TOWN OF NISKAYUNA

Planning Board and Zoning Commission Agenda

May 9, 2022 7:00 PM

REGULAR AGENDA MEETING

- I. CALL TO ORDER
- II. ROLL CALL
- III. APPROVAL OF MINUTES
 - 1. April 25, 2022
- IV. PUBLIC HEARINGS
- V. PRIVILEGE OF THE FLOOR
- VI. UNFINISHED BUSINESS
- VII. NEW BUSINESS
- VIII. DISCUSSION ITEM
 - 1. 2341 Nott St. E. ShopRite Plaza site plan app. for placing a Chase Bank ATM machine in the plaza parking lot
 - 2. 2303 Nott St. E. ShopRite Plaza Starbucks site plan app. for renovations and new signage for Starbucks
 - 3. 1 Glen Eddy Drive site plan app. for main entrance and Dining Room additions
 - 4. 3333 Consaul Rd. Niskayuna Square / Hannaford Supermarket Plaza -- site plan app. for sidewalk improvements including the addition of an ADA ramp

IX. REPORTS

1. Planning Department Updates

X. COMMISSION BUSINESS

1. Discussion on Planning Board approvals/conditions

XI. ADJOURNMENT

NEXT MEETING: May 23, 2022 at 7 PM

To be Held in the Town Board Room & via Remote Software

VI.

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UNFINISHED BUSINESS

No unfinished business tonight.

1	TO	OWN OF NISKAYUNA
2	Plannin	g and Zoning Commission
3		Hybrid Meeting
4		Meeting Minutes
5		April 25, 2022
6	Members Present:	Kevin Walsh, Chairman
7 8		Chris LaFlamme David D'Arpino
9		Leslie Gold
10		Nancy Strang
11	Also Present:	Laura Robertson, Town Planner
12		Alaina Finan, Town Attorney
13		Clark Henry, Assistant Planner (virtual)
14	I. CALL TO ORDER	
15	Chairman Walsh called the hybrid r	meeting to order at 7:00 P.M.
16	II. ROLL CALL	
17	Mr. Skrebutenas, Ms. Shenfield, Mr.	r. Khan and Mr. McPartlon were absent/excused tonight.
18	III. MINUTES	
19	April 11, 2022	
20	Mr. D'Arpino made a motion to app	prove the minutes and Mr. LaFlamme seconded the motion.
21	Upon voting, the minutes were appr	roved unanimously 5-0.
22	Mr. D'Arpino	AYE
23	Ms. Gold	AYE
24	Mr. LaFlamme	AYE
25	Ms. Strang	AYE
26	Chairman Walsh	AYE
27		
28	IV. PUBLIC HEARINGS	
29	There were no public hearings.	
30	V. PRIVILEGE OF THE FL	OOR
31 32	No residents provided comments person participation.	for privilege of the floor by email, videoconference or in-

VII. NEW BUSINESS

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- 1. RESOLUTION: 2022—09: A Resolution for site plan approval for a 20 ft. long x 8 ft. wide storage container in the parking lot of Goodyear Tire at 3713 State Street.
- Mr. Bundy was present virtually for the meeting. The Board asked for clarification of how and
- where the large commercial tires that would be stored in the proposed container will be installed
- on the vehicles. More specifically, they asked if the large commercial trucks or 18-wheelers will
- come to 3713 State Street to have new tires installed. Mr. Bundy stated that the site will be for
- storage of the tires only. The installation of the tires will not happen on site. They are installed
- on the highway or at a truck yard. The tires will be delivered to the site via box truck only.
- 44 Mr. LaFlamme stated he went to the site and examined the location of the proposed container.
- He stated that although there are homes in the vicinity, they do not seem to have sightlines to the
- container. He added that once the container is in he will review the site again to assess the
- opportunity for possible buffering options.
- Chairman Walsh asked for other questions or comments. Hearing none, he called for a vote on
- 49 the resolution.
- 50 Upon voting, the resolution was passed 5-0.
- 51 Mr. D'Arpino AYE
- 52 Ms. Gold AYE
- 53 Mr. LaFlamme AYE
- 54 Ms. Strang AYE
- 55 Chairman Walsh AYE

56 VIII. DISCUSSION ITEMS

1. 2341 Nott St. – St. James Plaza – Site plan app. for placing a Chase Bank ATM machine in the Shop Rite parking lot.

- Ms. Robertson noted that the applicants contacted the Planning Office on Monday 4/25/22 and
- asked to be moved to the 5/9/22 Planning Board meeting to provide them additional time to
- resolve design issues. She continued by stating that the Planning Office notified the applicants
- that they would provide the Planning Board with a very brief update on the project and notify
- them of the request to be moved to the 5/9/22 meeting. The applicants were not present at the
- 64 meeting tonight.
- 65 Ms. Robertson updated the Board that after much research by the Planning Department, it
- appears that there is enough parking for the project without needing a waiver from the Planning
- Board. The original PDD allowed for 625 parking spaces, and there may have been a further
- deduction allowed later, so this proposal still exceeds the total number of parking spaces as
- 69 required by the PDD. Ms. Robertson stated she counted parking spaces from an aerial to visually
- 70 confirm the spaces in the drawings still existed.
- Mr. D'Arpino stated he has not emailed the bollard examples to the applicant yet but will follow
- 72 through with the email before next meeting. Chairman Walsh stated the applicant will be
- available for the next meeting on May 9.

- Ms. Robertson discussed with the Board some conditions that should be addressed with the
- applicant and the landlord of the property. Per the original PDD there were landscape conditions
- that stated the landscape need to be maintained. The landlord has been faulty on this condition.
- 77 Chase Bank has proposed a landscape plan that will include creating a landscaped barrier for
- 78 traffic calming.
- Ms. Robertson also discussed requiring the applicant to paint of repaint crosswalks as part of
- their parking lot improvements, and fix some pavement / catch basin issues near the project.

81 IX. REPORTS

1. Planning Department Updates

- Ms. Robertson stated the Planning Board and Tree Council did a site walk at the Trinity Baptist
- Church on Balltown Road. She stated that Ms. Gold and Ms. Strang were present from the
- Planning Board and Ms. Carey and Mr. Mahar were present from the Tree Council. Ms.
- Robertson stated that the Tree Council gave suggestions on tree planting and requested that the
- applicant protect the mature white pines. The Council stated they would put a proposal together
- for the applicant.

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- At the site, the applicant agreed with the suggestions and asked if they could email the
- recommendations before Wednesday so he could present it at the Church meeting. Ms.
- Robertson added that she asked if some of the parking could be eliminated but the applicant
- 93 stated that during certain events all of the parking is used. Ms. Robertson stated that the night
- they did the walkthrough, most spots were taken that evening due an event going on. He added
- 95 that the side parking is also used for athletics including basketball. Mr. McPartlon has
- volunteered to be project lead. Ms. Robertson noted that the CAC asked if a daycare was going
- of to be run out of the church. The applicant stated no. Ms. Strang noted that she was supportive of
- oreating a bigger buffer of existing trees to the existing neighbors, and agrees with the locations
- 99 for the new planted trees.

100

- 101 Ms. Robertson discussed the project at the GE Global Research site. She stated they will be on
- the May 9 agenda. She hopes they reach out to Mr. D'Arpino for revised building plans that can
- be discussed at the meeting. She added that the applicants met with the Tree Council and the
- Tree Council will submit their recommendations to the Board and the applicant.

105 106

X. COMMISSION OF BUSINESS

- Mr. D'Arpino stated the ARB will be meeting on May 4. He stated that the Board will be
- reviewing Kelts Farm Town Homes and at 1206 Ruffner Road for a garage addition.

109 XI. ADJOURNMENT

- 110 Chairman Walsh asked for a motion to adjourn. Ms. Gold made a motion to adjourn and it was
- seconded by Ms. Strang. The meeting was adjourned at 7:30 pm.



TOWN OF NISKAYUNA

PLANNING BOARD AND ZONING COMMISSION

AGENDA STATEMENT

AGENDA ITEM NO. VIII. 1	MEETING DATE: 5/9/22
ITEM TITLE: DISCUSSION: 2341 Nott St. – ShopRite Plaza Chase Bank ATM machine in the plaza parking lot	a – site plan app. for placing a
PROJECT LEAD: Mike Skrebutenas	
APPLICANT: Kristopher Miller, agent for the owner	
SUBMITTED BY: Laura Robertson, Town Planner	
REVIEWED BY: Conservation Advisory Council (CAC) OTHER:	f Appeals (ZBA) □ Town Board
ATTACHMENTS: ☐ Resolution ■ Site Plan ☐ Map ☐ Report ☐ Other:	

SUMMARY STATEMENT:

Kristopher Miller, agent for the owner of 2341 Nott St, submitted an Application for Site Plan Review for the placement of a Chase Bank ATM in a portion of the Shop Rite parking lot.

BACKGROUND INFORMATION

2341 Nott St. is located within the C-N Neighborhood Commercial zoning district and the Town Center Overlay District.

The scope of work for the ATM project in the eastern most portion of the Shop Rite parking lot includes an ATM on a concrete pad, bollards, signature canopy, vehicle height detector bar and pole lighting. Lane striping and directional arrows will also be painted on the asphalt paving.

A 6-page drawing set entitled "Chase Bank Nott and Balltown ATM 2341 Nott Street Schenectady, NY 12309" by BHDP Lawrence Digennaro, Architect 302 W. 3rd Street, Suite 500, Cincinnati, OH 45202 dated 7-19-21 with a most recent revision of Rev 1 dated 4-1-22 was provided with the application and stamped "Received Apr 07 2022" by the Planning Department.

Setbacks

Zoning 220 Attachment 17 Schedule I-D C-N District column 2 lists the setback requirements for Food markets as: Front = 20', side = 15', rear = 25'. As proposed, the location of the ATM complies with all setback requirements.

Parking

The total required parking for Phase II of ShopRite Plaza (this parcel) has an existing deficit of 36 spaces. This proposal would bring the deficit to 44 (reduce the parking by an additional 8 spaces). However, there are cross parking easements across all the parcels in the plaza. With the cross easements in place, the total existing plaza deficit is 19 and this proposal would bring the deficit up to 27. The Town does not receive complaints of not enough parking in the plaza however, and for a plaza that size the deficit is small. It is worth noting though, that parking is being removed from the parcel that has the least amount of parking to begin with.

Plaza	Parking Summ	ary			
Existing		Required	Provided		
	Phase I	465	482	17	Surplus
	Phase II	203	167	36	Deficit
	TOTAL	668	649	19	Deficit
Propose	d				
	TOTAL	668	641	27	Deficit

Please see further discussion on initial parking PDD requirements below.

Lighting

Light Pole and Fixture

Zoning code Chapter 220 Zoning Article VIIIA. Town Center Overlay District, Neighborhood Commercial and Highway Commercial Standards: establishes design criteria for an identifiable center of the Town to further define a sense of community and promote traditional architecture. Section 220-48.5 Pedestrian and streetscape amenities C minimum performance criteria (3) Lighting (c) states the following: "Pole-mounted lighting in accordance with Planning Board guidelines shall not exceed a pole height of 22 feet from finished grade".

As proposed, page A102 of the drawing set includes a light pole with an area light measuring 23' high (3' high concrete base + 20' high light pole) located at the entrance to the ATM machine. Therefore, a waiver of 1' (23 - 22) of pole height from finished grade is required.

Minimum performance criteria subsection (3) Lighting (d) includes the following: "Light sources for all lighting shall be metal halide".

As proposed, page A104 of the drawing set includes a lighting fixture described as "Model ALED2T150N (Type II) 4000K LED 120-277V 151.4 Watts LED area light". Therefore, a waiver for an LED light rather than a metal halide light is required.

Lighting of Outdoor Areas

Zoning code Chapter 220-48.5 C (3) Lighting states lighting shall follow "Article VIIIB Guidelines for Lighting of Outdoor Areas under Site Plan Review".

- Table 1 lists Neighborhood shopping areas as "Moderate Activity" areas.
- Table 2 lists the guideline for maintained horizontal illuminance for general parking and pedestrian areas as 0.3 Footcandles and driveway access as 0.8 Footcandles.

As proposed, page A105 of the drawing set includes a photometric plan of the project area. The area immediately around the ATM is illuminated to approximately 5 fc. The illumination at a 25' radius from the project site is illuminated to approximately 2 fc. The illumination level at a radius of 50' from the project site is typically significantly less than 1 fc and equivalent to the larger parking lot area.

Signs

Section 220-4 Signs of the Niskayuna zoning code establishes standards to promote signs that are visually compatible with their surroundings and are of appropriate design and materials.

Subsection D Prohibited signs: The following signs shall be prohibited in the Town Center Overlay District: includes (5) Pylon signs.

Pages A102, A103 and A104 of the aforementioned drawing set include design details for the proposed ATM. Several portions of the ATM station infrastructure and associated graphical displays should be reviewed by the Board relative to the requirements set forth in Section 220-4 of the zoning code. The drawings include a "non-illuminated signage option" that reads "CHASE" followed by the Chase Bank logo on one of the canopy legs.

Section 220-48.4 Signs E Minimum performance criteria (5) Logo states: "In the event that a picture logo is displayed on a sign, it shall be incorporated into the permitted sign area to comprise not more than 30% of the sign area". As proposed, the drawings show a two-sided "non-illuminated octagon signage option" located above the aluminum "signature canopy" that partially shields the ATM machine from weather. The logo comprises 100% of the sign area so a waiver for a sign with a logo covering 100% of the sign area may be required.

Summary Table of Zoning Relief

	Required	Provided	Notes
Parking Spaces	668	641	Reduction in 8 parking spaces still above 625 requirement
Light Pole	22' pole height	23' pole height	1' waiver for height
Lighting type	Metal Halide	LED	Waiver to LED
Signage Logo	Logo 30%	Logo 100%	Waiver on Logo %
"Chase" Sign		Chase sign on ATM	Addressed as part of waiver package

4/11/22 Planning Board (PB) meeting – Chris Quinn and Tom Riley spoke on behalf of Chase Bank and explained the project to the Board. The Planning Office noted the entire Shop Rite plaza is currently 19 parking spaces below code and the proposed ATM will consume 8 existing parking spaces leaving the shopping center 27 spaces below code. A discussion ensued regarding the impact the ATM is anticipated to have on the shopping center. The applicants stated that their data estimates 1,800 visits to the ATM per month (approx. 60 visits / day). They also indicated that ATMs rarely have more than 1 vehicle at the ATM and one additional vehicle waiting to use it. The Board agreed on the following action items for the Chase Bank site plan.

• Explore muting the colors used for the design of the ATM and associated apparatus to comply with Section 220-48.7 of the Niskayuna zoning code.

- Refresh all parking space striping.
- Repair existing parking lot potholes.
- Replant landscaping as advised by the Niskayuna Tree Council.

PDD PARKING

Planning Staff has researched the initial approval of the PDD by the Town Board and recognizes that the Town Board approved full build out of the PDD with a parking requirement of 625 spaces. The PDD was given a 20% reduction in the total required spaces of 781 by the Town Board due to shared parking across parcels. The Planning Board may have allowed a further reduction to 602 in 1996 – but the clearest direction staff can find is to ensure 625 parking spaces in the plaza.

Given these facts, the Planning Board has the authority to work with the developer on parking spot configuration, provided they do not dip below the 625 originally approved, so this project would not need a referral to the Zoning Board of Appeals. However, it should be noted the second floor of Phase 2 of the plaza is largely vacant, so requiring staff to park in the rear of the building and keep front spots open to customers would be critical to any reduction in parking – as well as ensuring the remainder of the PDD requirements are met – including landscaping, pedestrian crosswalks and vehicular flow.

<u>4/25/22 Planning Board (PB) meeting</u> – The project was on the posted agenda for the 4/25/22 PB meeting but late in the day on Friday 4/22/22 the applicant asked to be pushed out to the 5/9/22 meeting. This was to allow them additional time to complete the action items that were identified at the 4/11/22 meeting most notably concepts for a more muted color scheme more in line with the requirements of section 220-48.7 for the Town Center Overlay District (TCOD). The PB discussed the project very briefly at the 4/25/22. The discussion was limited to the new parking space information the Planning Office noted in the Agenda Statement, above.

<u>5/4/22 Architectural Review Board (ARB) meeting</u> – The ARB reviewed the drawings of the proposed ATM machine and associated apparatus. They agreed that the bright blue color should be restricted to the Chase Bank logo and that more muted colors should be used on the protective bollards and ATM housing panels. The Planning Office (PO) noted that the applicant is on the agenda for the 5/9/22 PB meeting and a new color scheme is expected to be introduced at that time. The ARB agreed to review the proposal again after 5/9/22.


The applicant is on the agenda this evening to provide an update on the action items that were identified at the 4/11/22 PB meeting.

TKO INSTALLATIONS, INC. CHASE BANK NOTT AND BALLTOWN ATM 2341 NOTT STREET SCHENECTADY, NY 12309

SITE PLAN

LAWRENCE DIGENNARO, ARCHITECT 302 W. 3rd STREET, SUITE 500, CINCINNATI, OHIO 45202 PHONE: 513.271.1634 FAX:513.271.7017



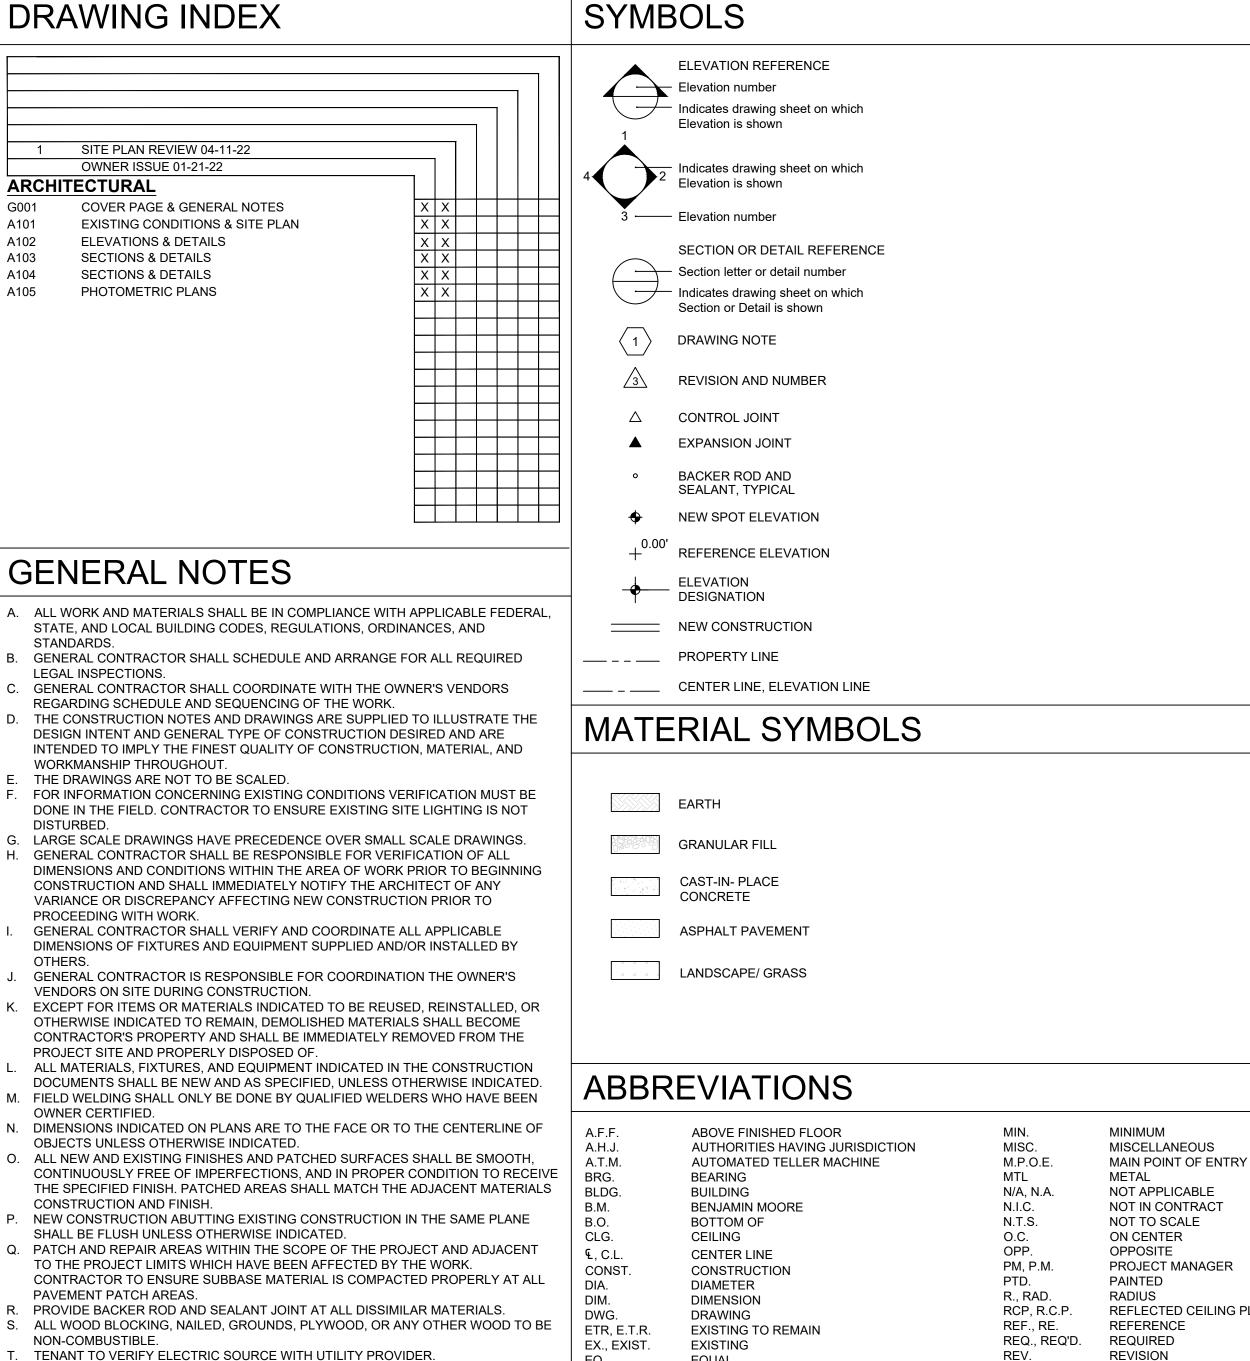

NOT APPLICABLE NOT IN CONTRACT PROJECT MANAGER REFLECTED CEILING PLAN REVISION FEET / FOOT RO, R.C **ROUGH OPENING** FLUOR. **FLUORESCENT** SQUARE FOOT FIBER REINFORCED PLASTIC FRP, F.R.P FRT, F.R.T. FIRE RETARDANT TREATED **SPECIFICATIONS GENERAL CONTRACTOR** STANDARD G.W.B GYPSUM WALL BOARD TOP OF GYP. BD. GYPSUM BOARD **TYPICAL** U.N.O., U.O.N UNLESS OTHERWISE INDICATED HORZ. HORIZONTAL UNDERSIDE LAVATORY VERT. VERTICAL LGMF LIGHT GAUGE METAL FRAMING VERIFY IN FIELD LANDLORD MFR, MFGR MANUFACTURER WITHOUT




TENANT TO ENSURE STORM SURFACE DRAINAGE FUNCTIONS PROPERLY.

V. ALL WORK INCLUDING BUILDING PERMIT, CONSTRUCTION, TESTING, ETC. BY

W. ALL WORK TO BE COMPLETED BY TENANT.

BUILDING CODE

DRIVE-UP A.T.M.

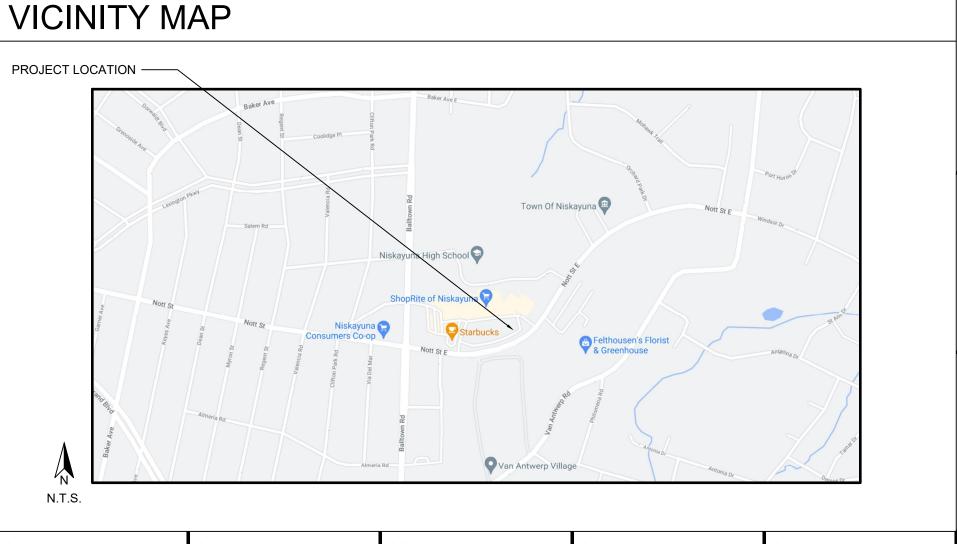

Project Manager


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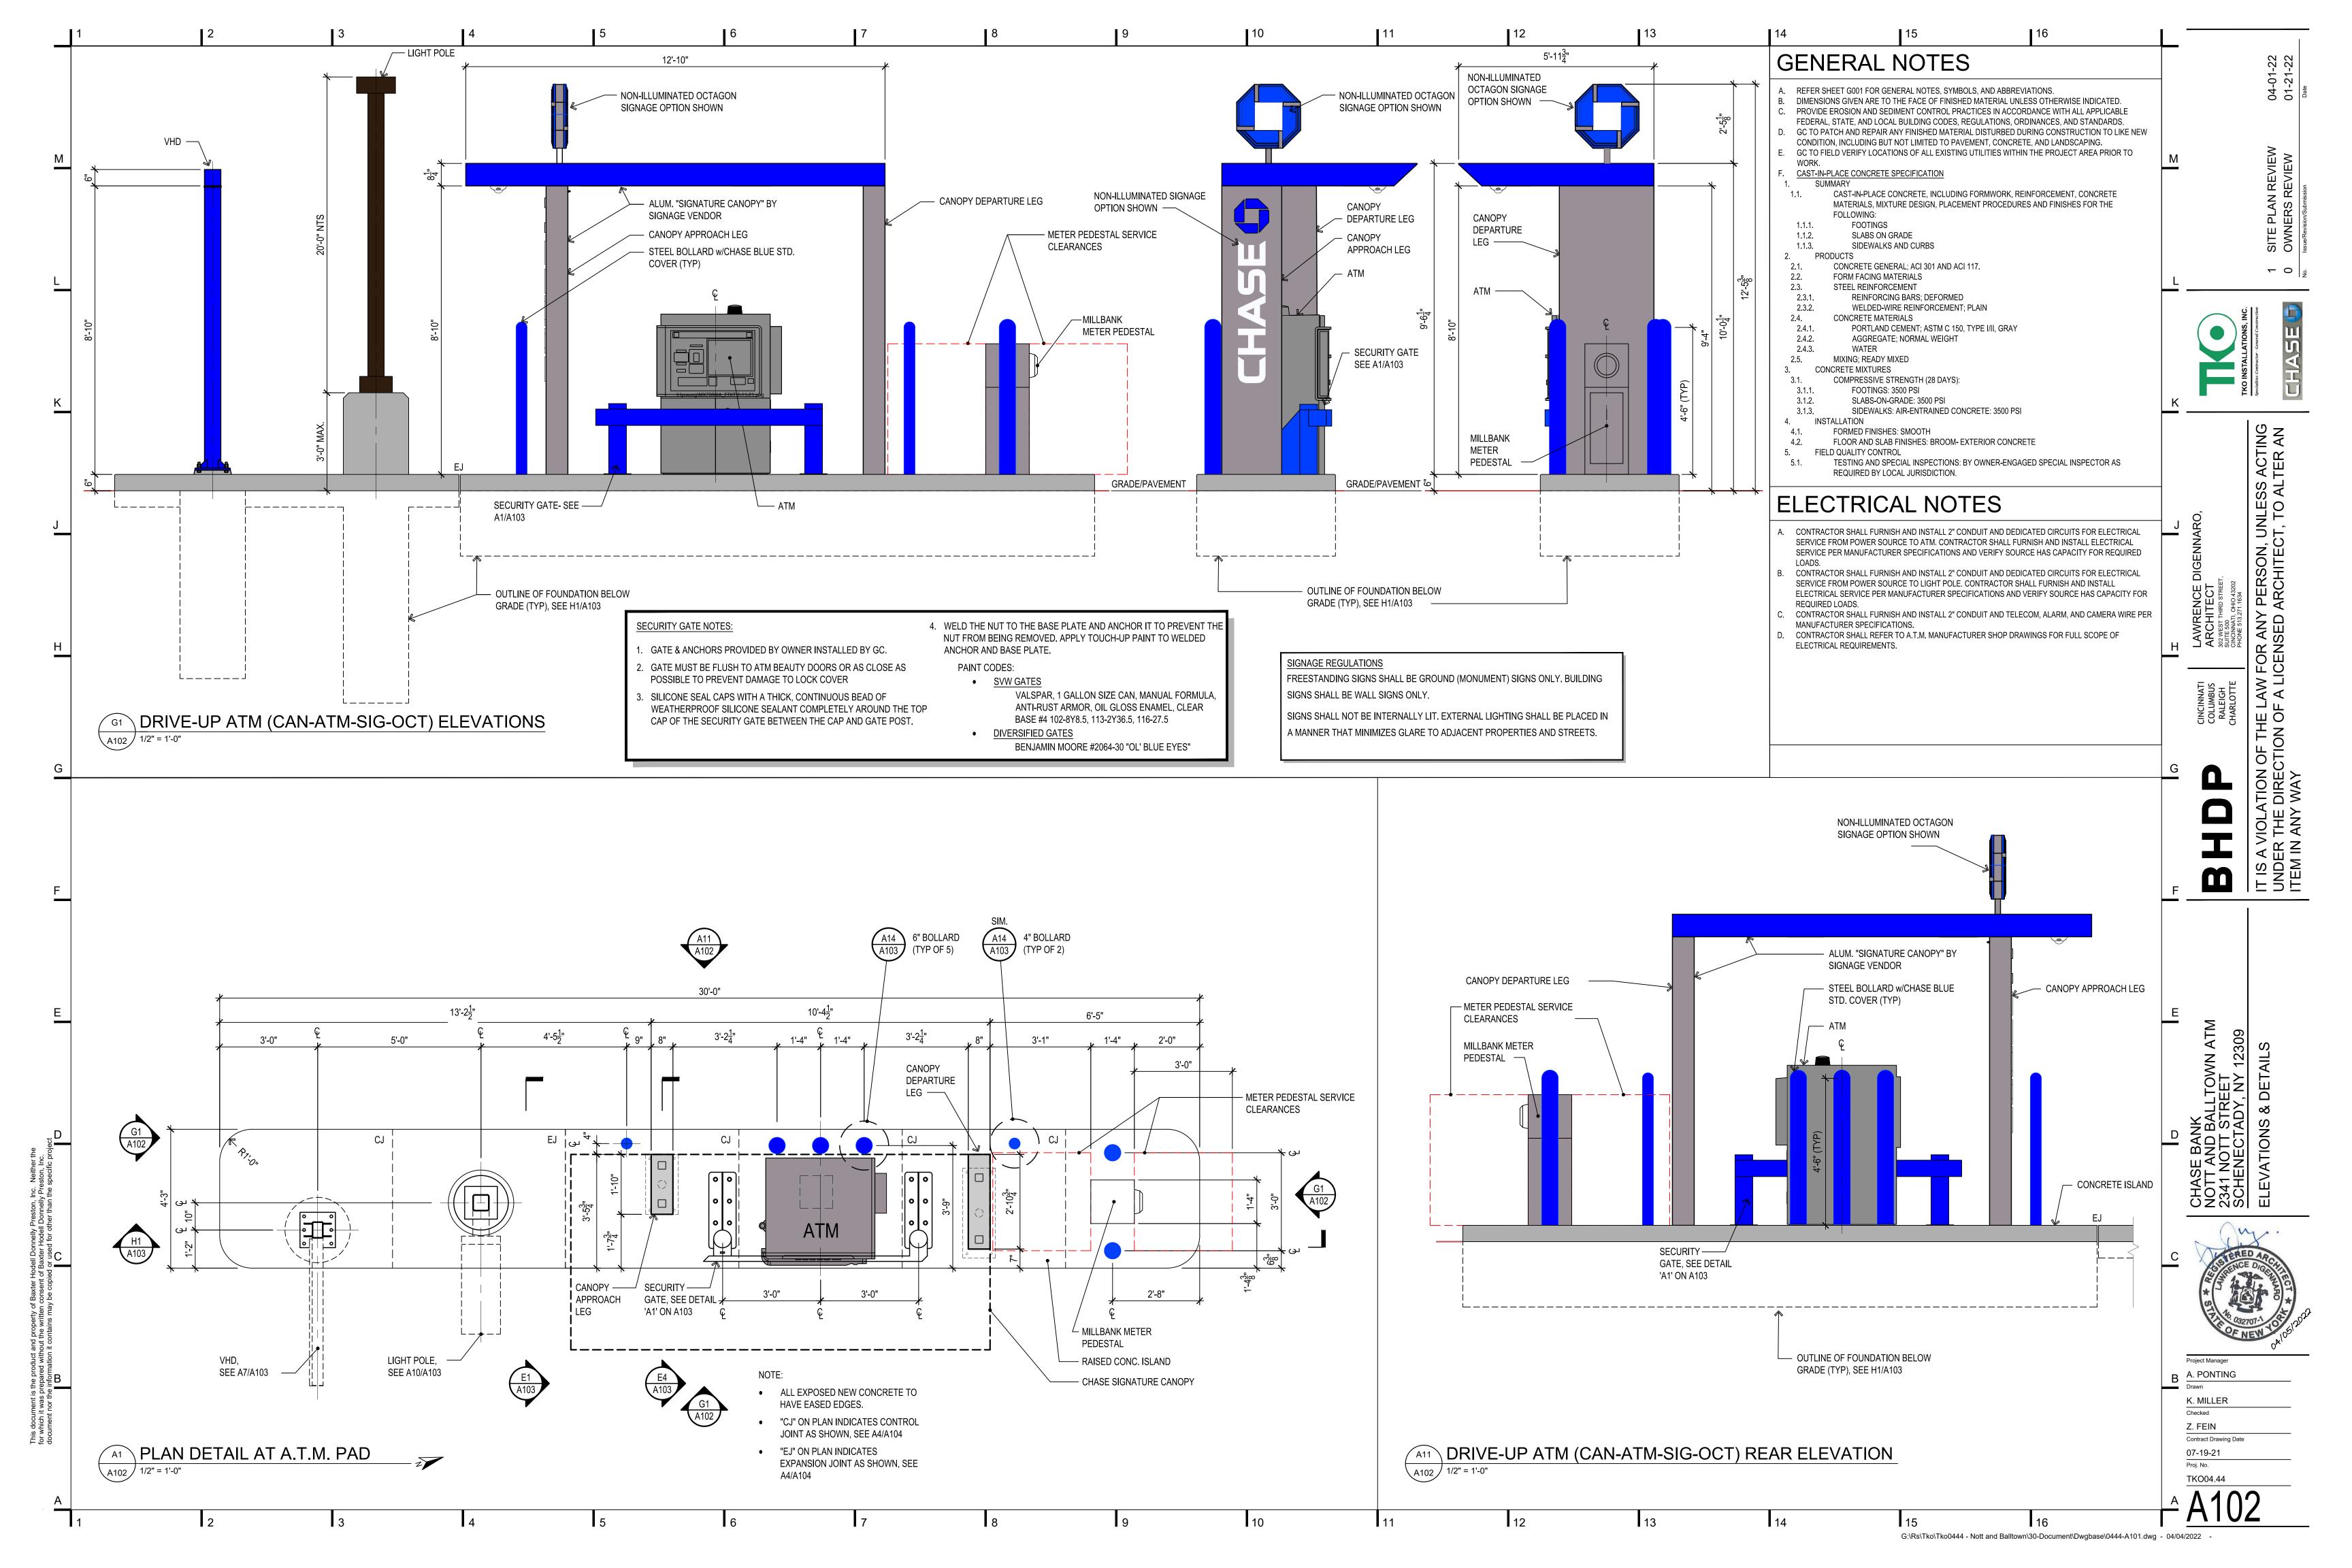
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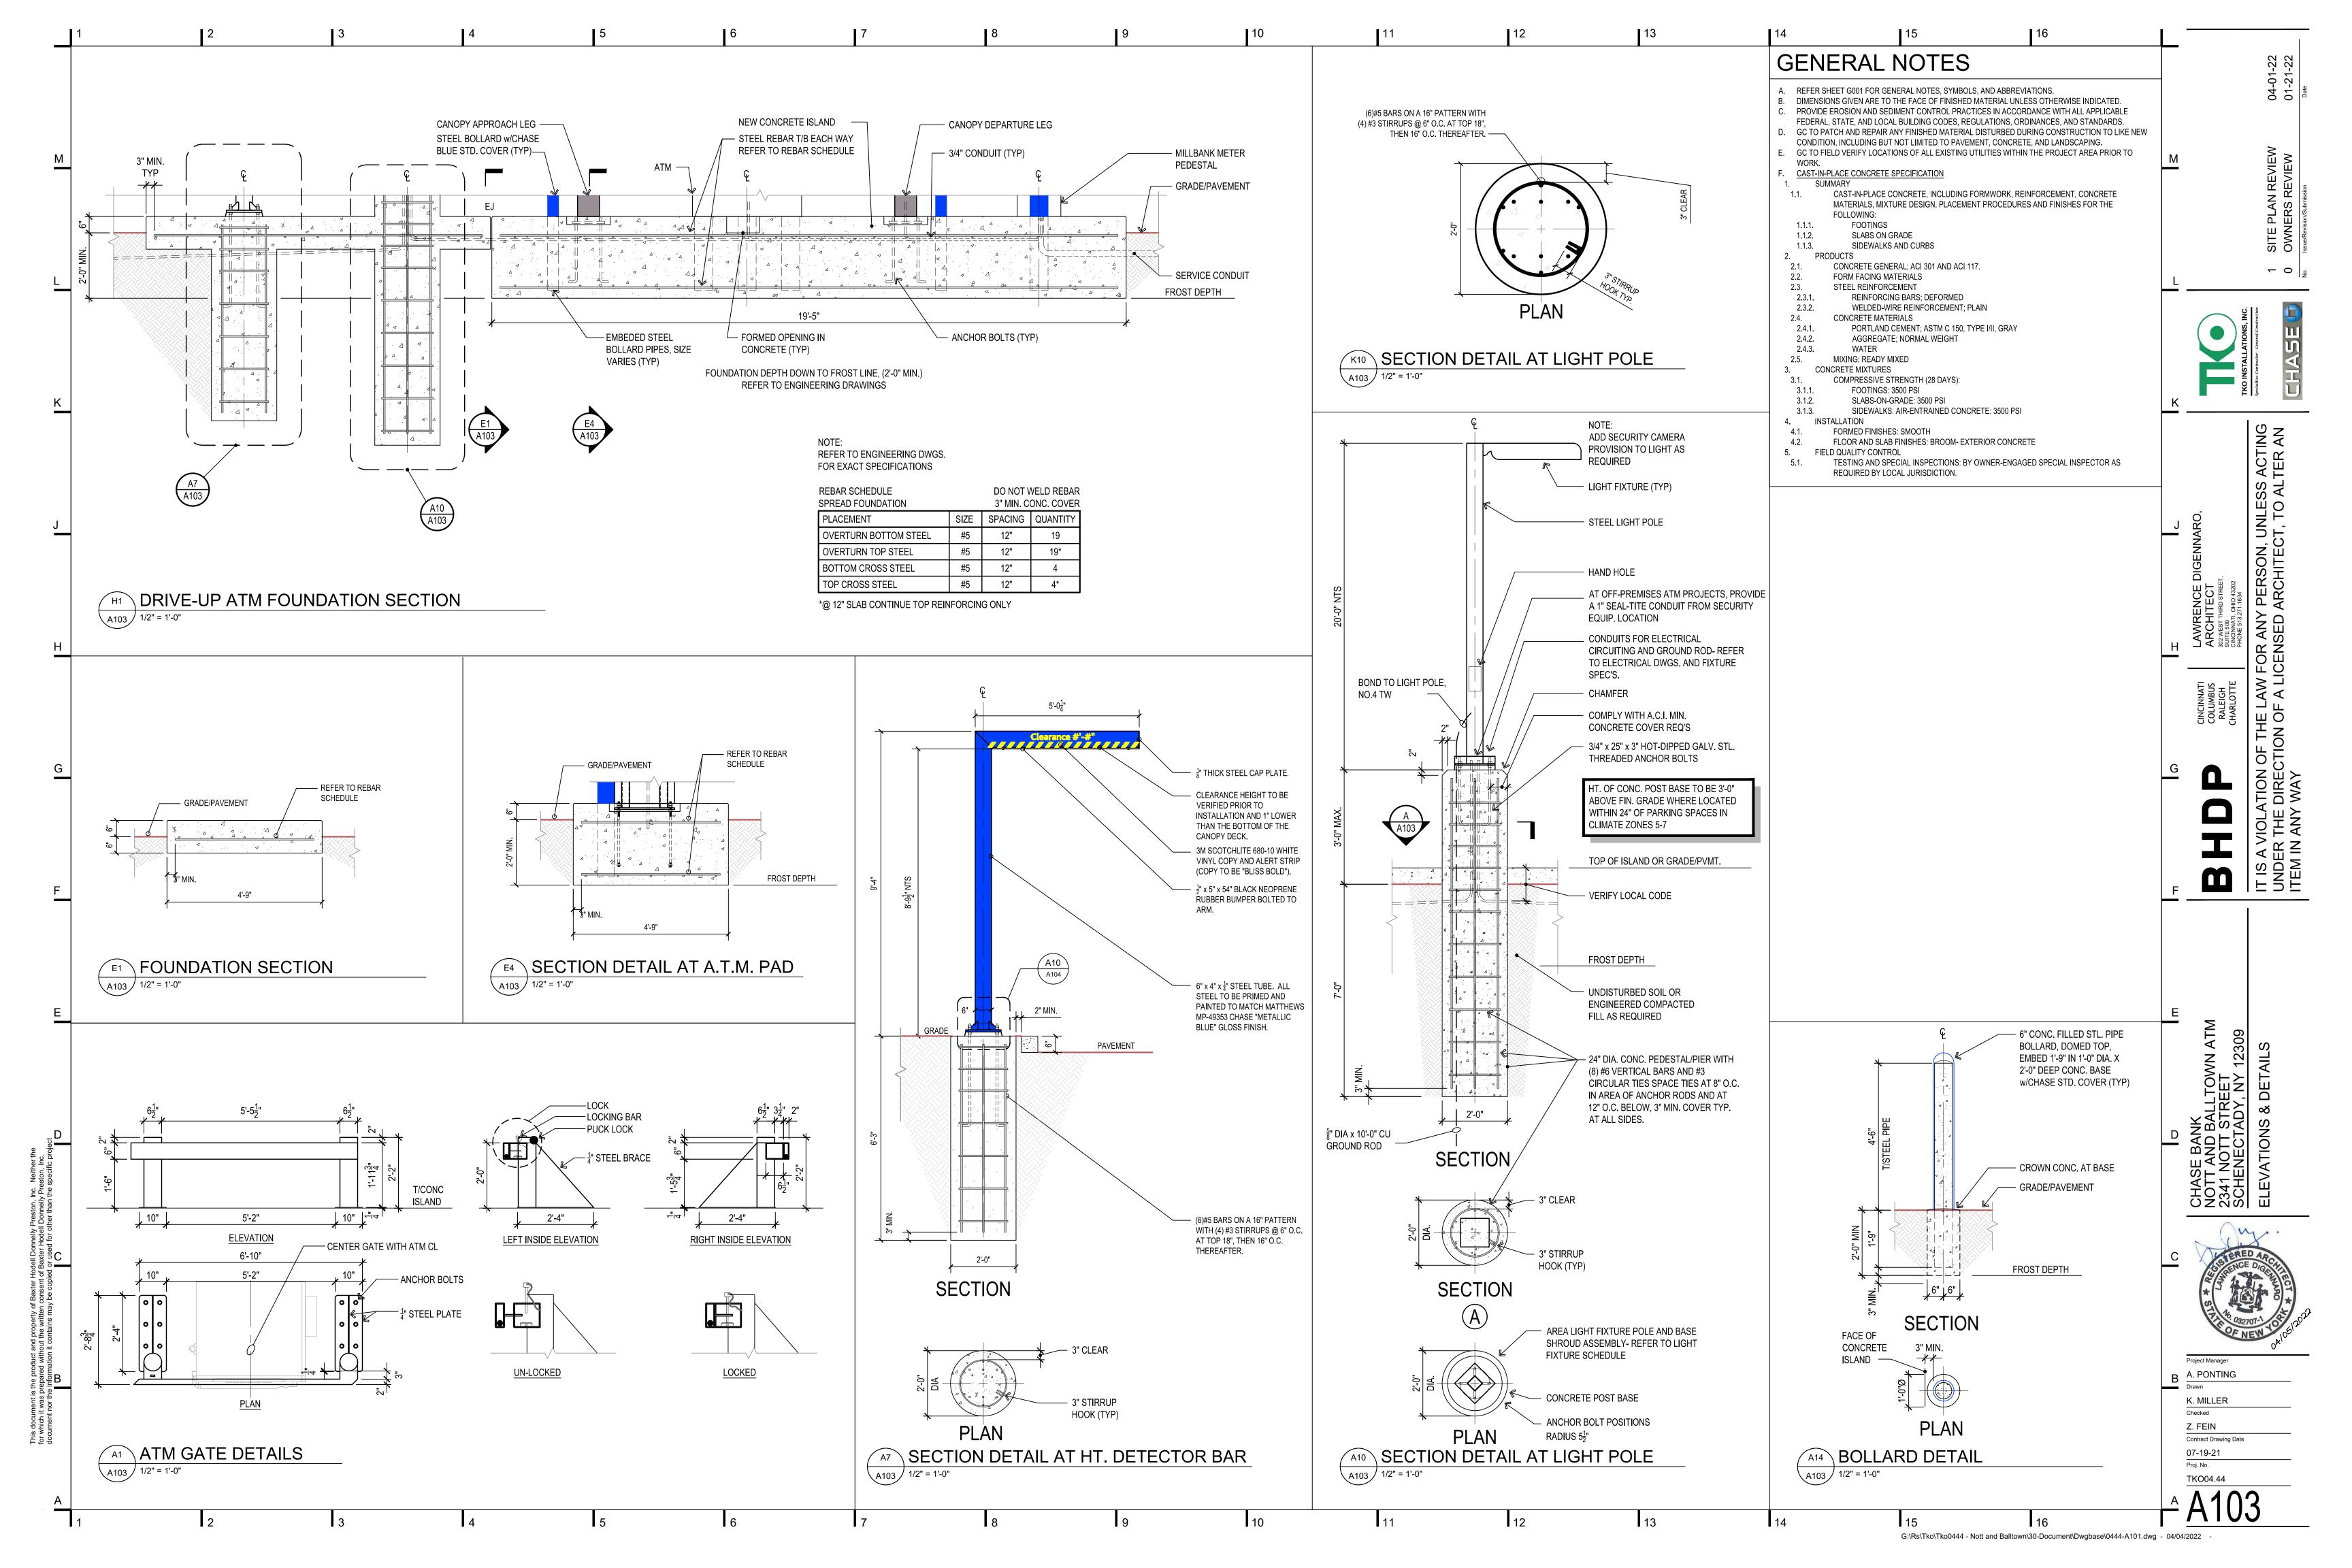
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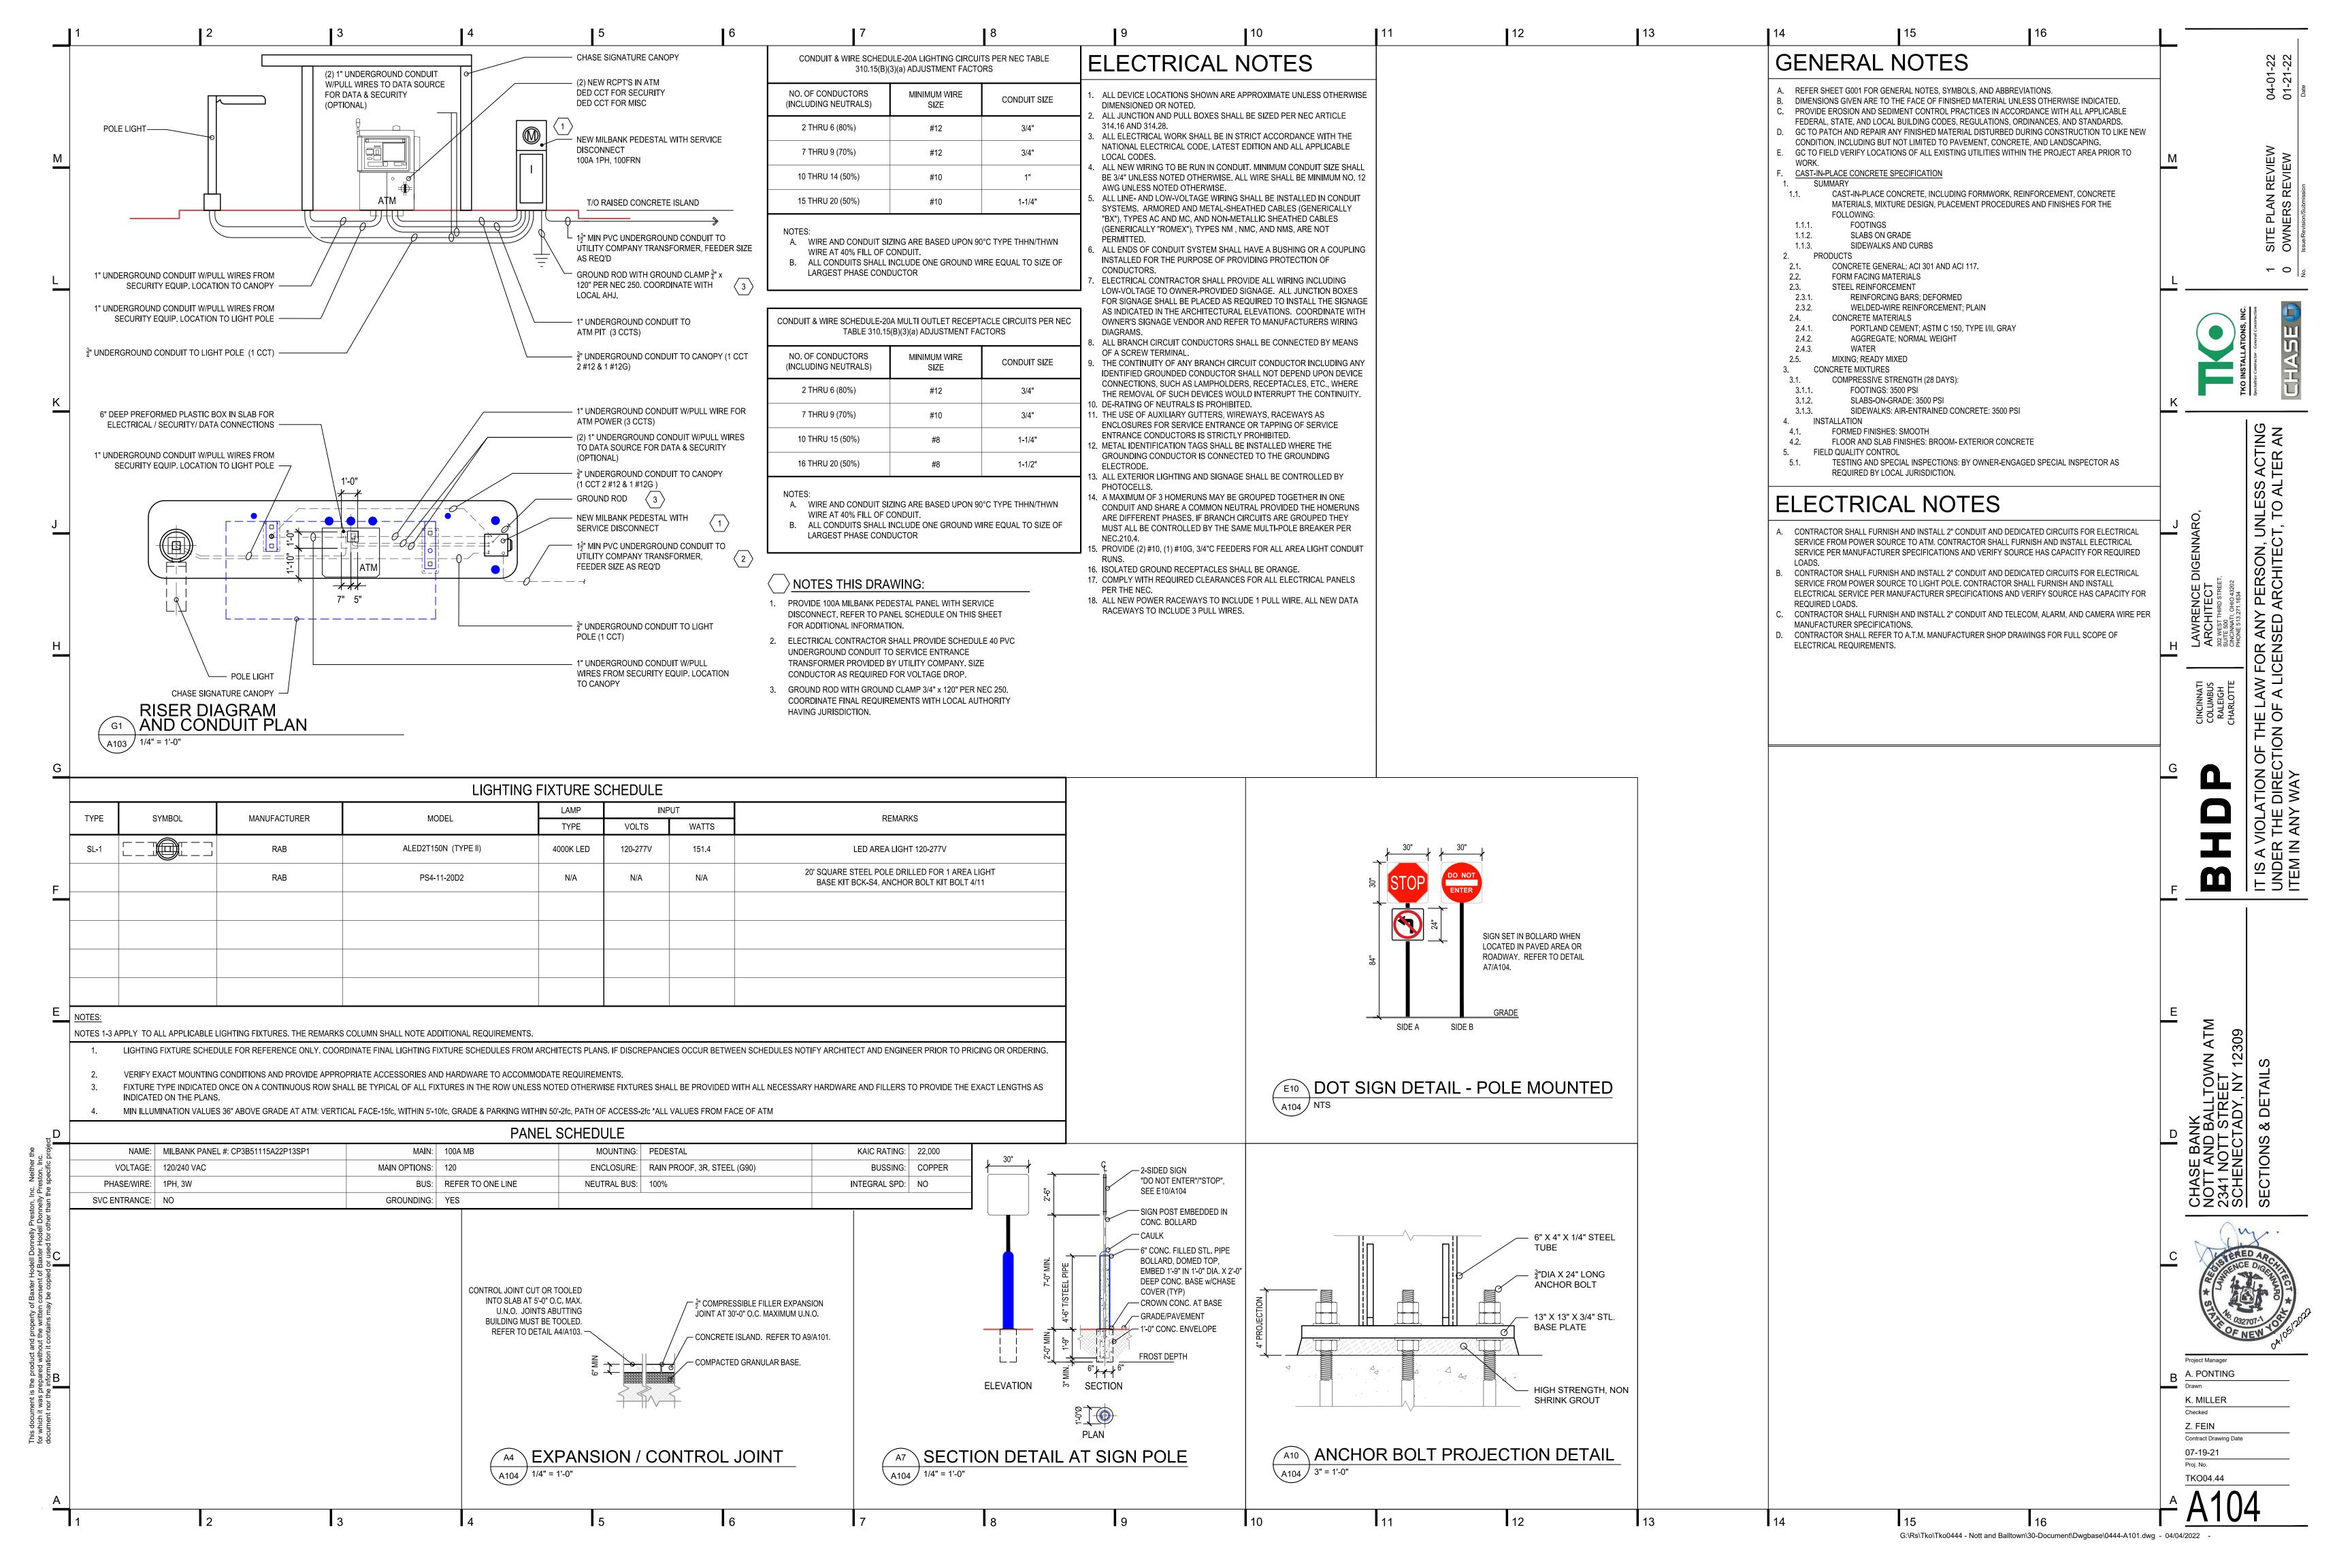
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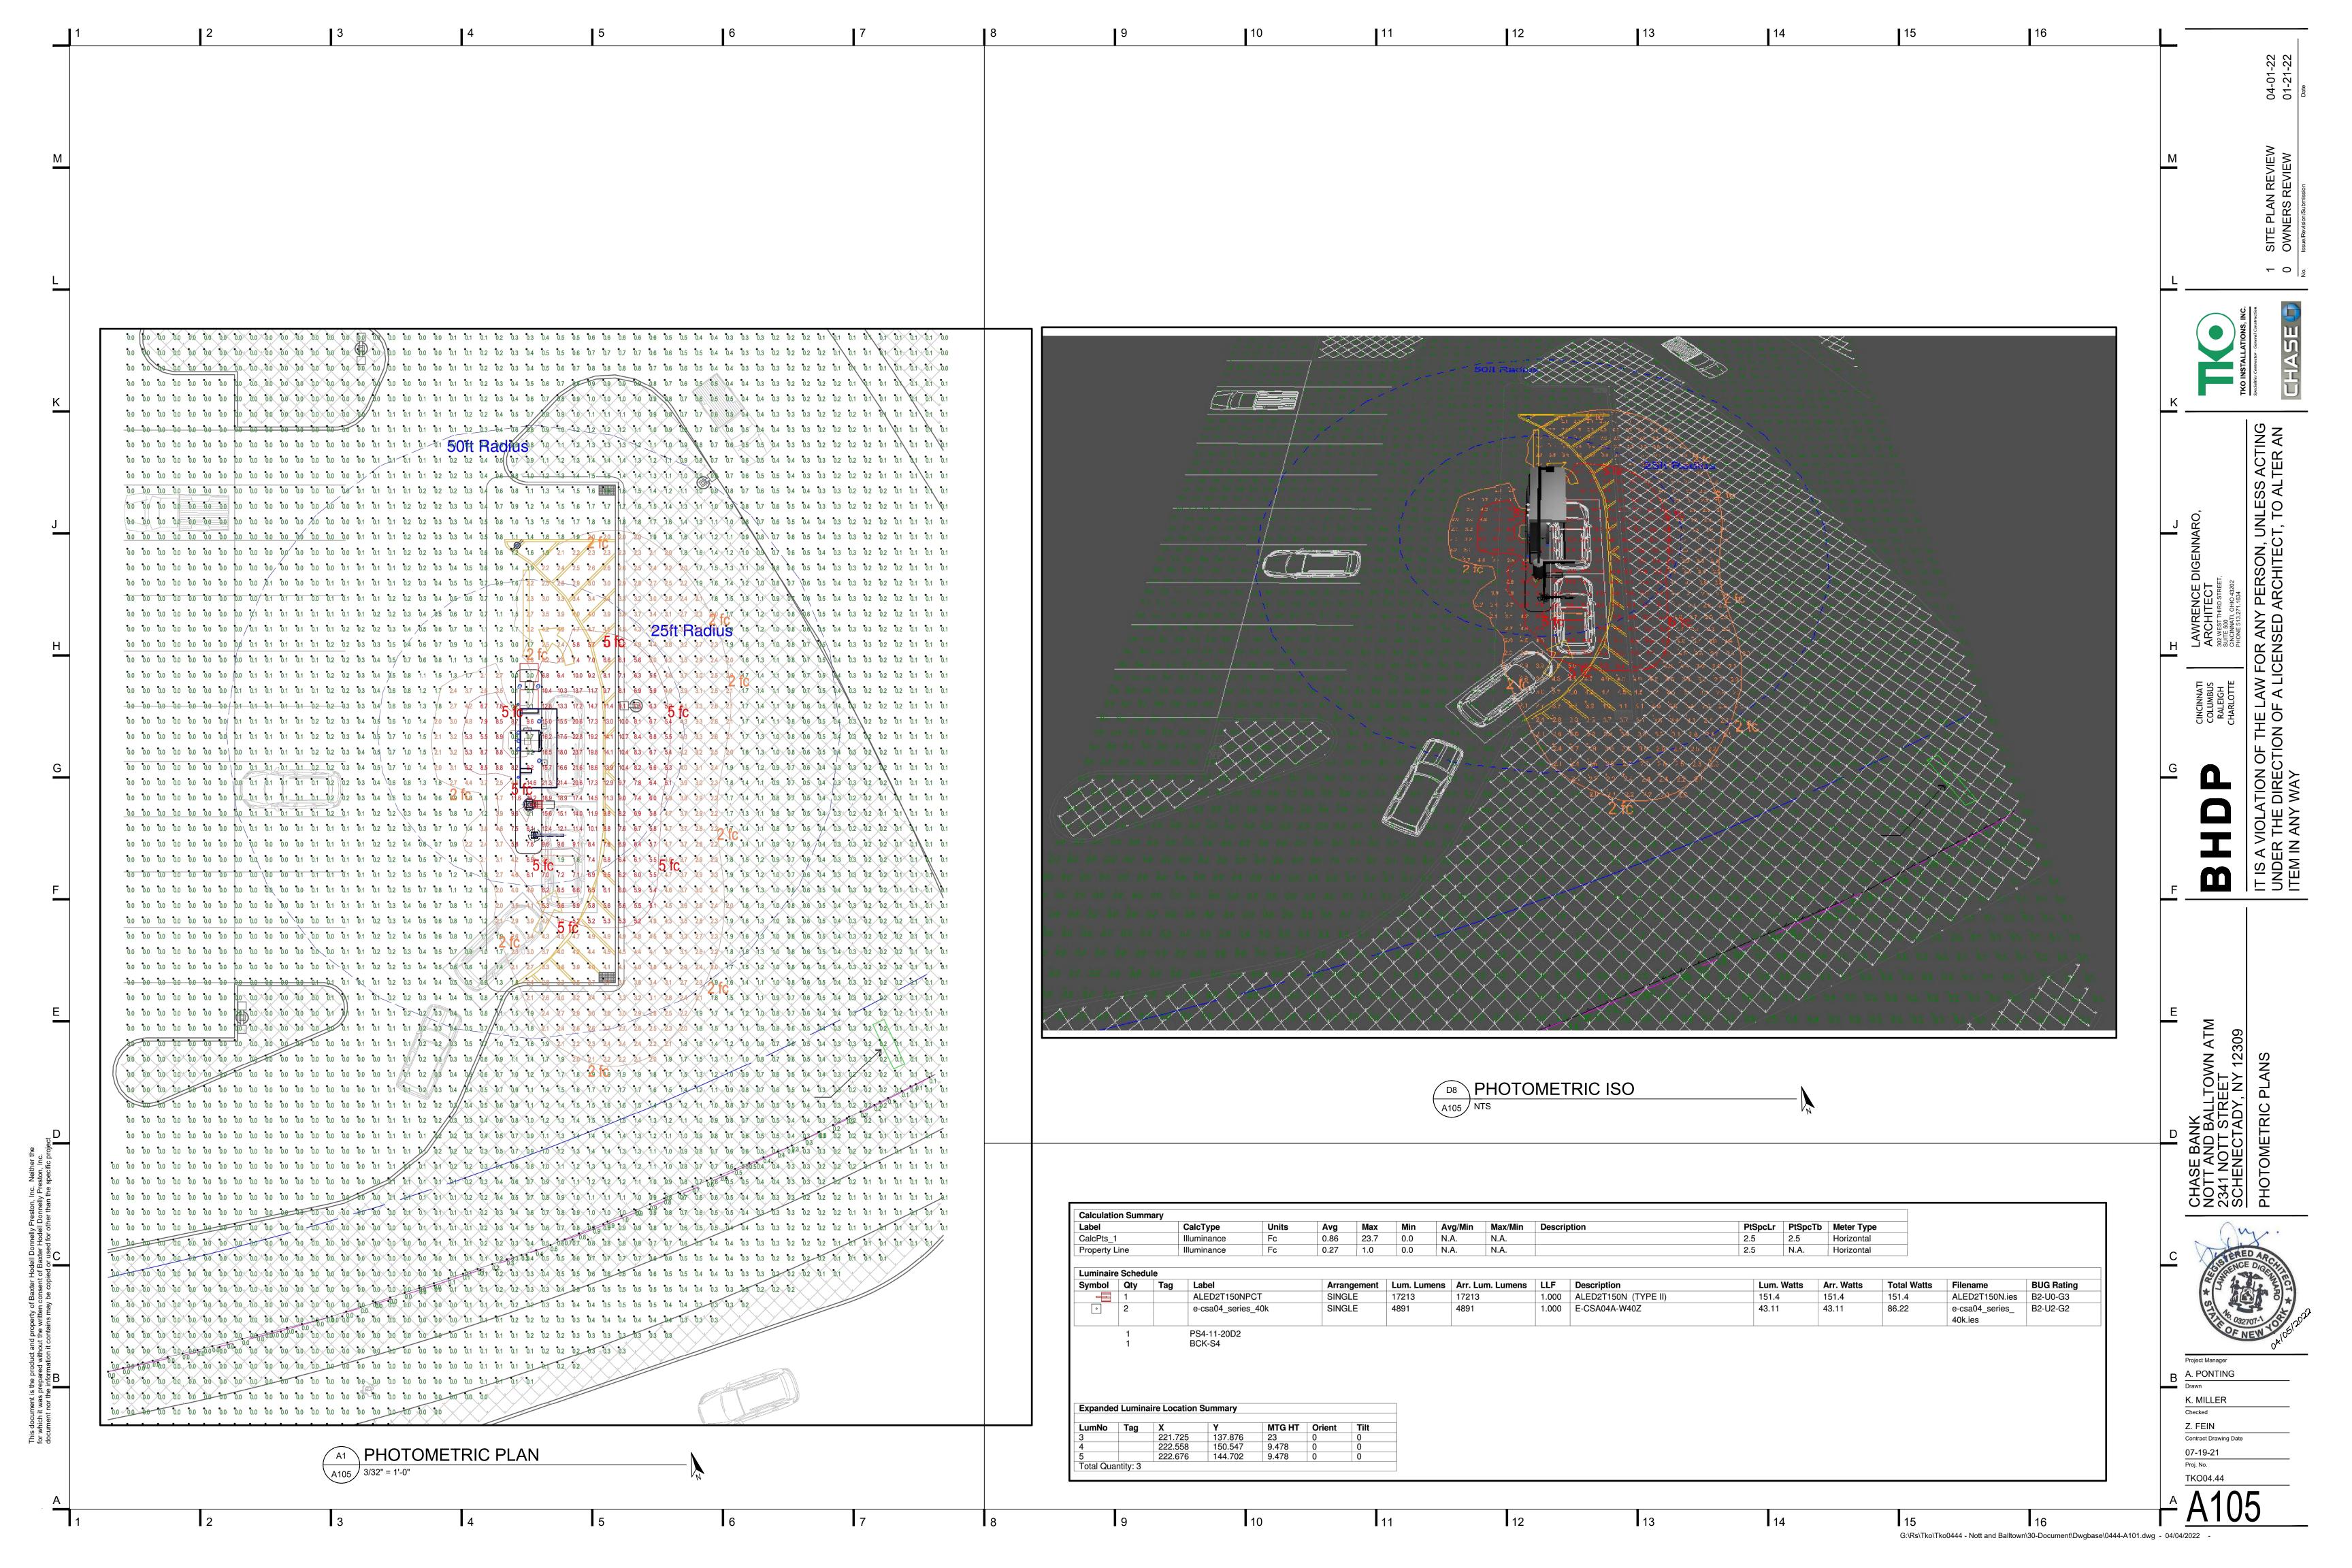
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TOWN OF NISKAYUNA

PLANNING BOARD AND ZONING COMMISSION

AGENDA STATEMENT

AGENDA ITEM NO. VIII. 2	MEETING DATE: 5/9/2022
ITEM TITLE: DISCUSSION: 2303 Nott St. E – Starbucks – interior and exterior renovations to the shop.	Application for Site Plan Review for
PROJECT LEAD: TBD	
APPLICANT: Daniel Brennan, Starbuck permit agent	
SUBMITTED BY: Laura Robertson, Town Planner	
REVIEWED BY: Conservation Advisory Council (CAC) Zoning Board of OTHER:	f Appeals (ZBA) \square Town Board
ATTACHMENTS: ☐ Resolution ■ Site Plan ☐ Map ☐ Report ☐ Other:	

SUMMARY STATEMENT:

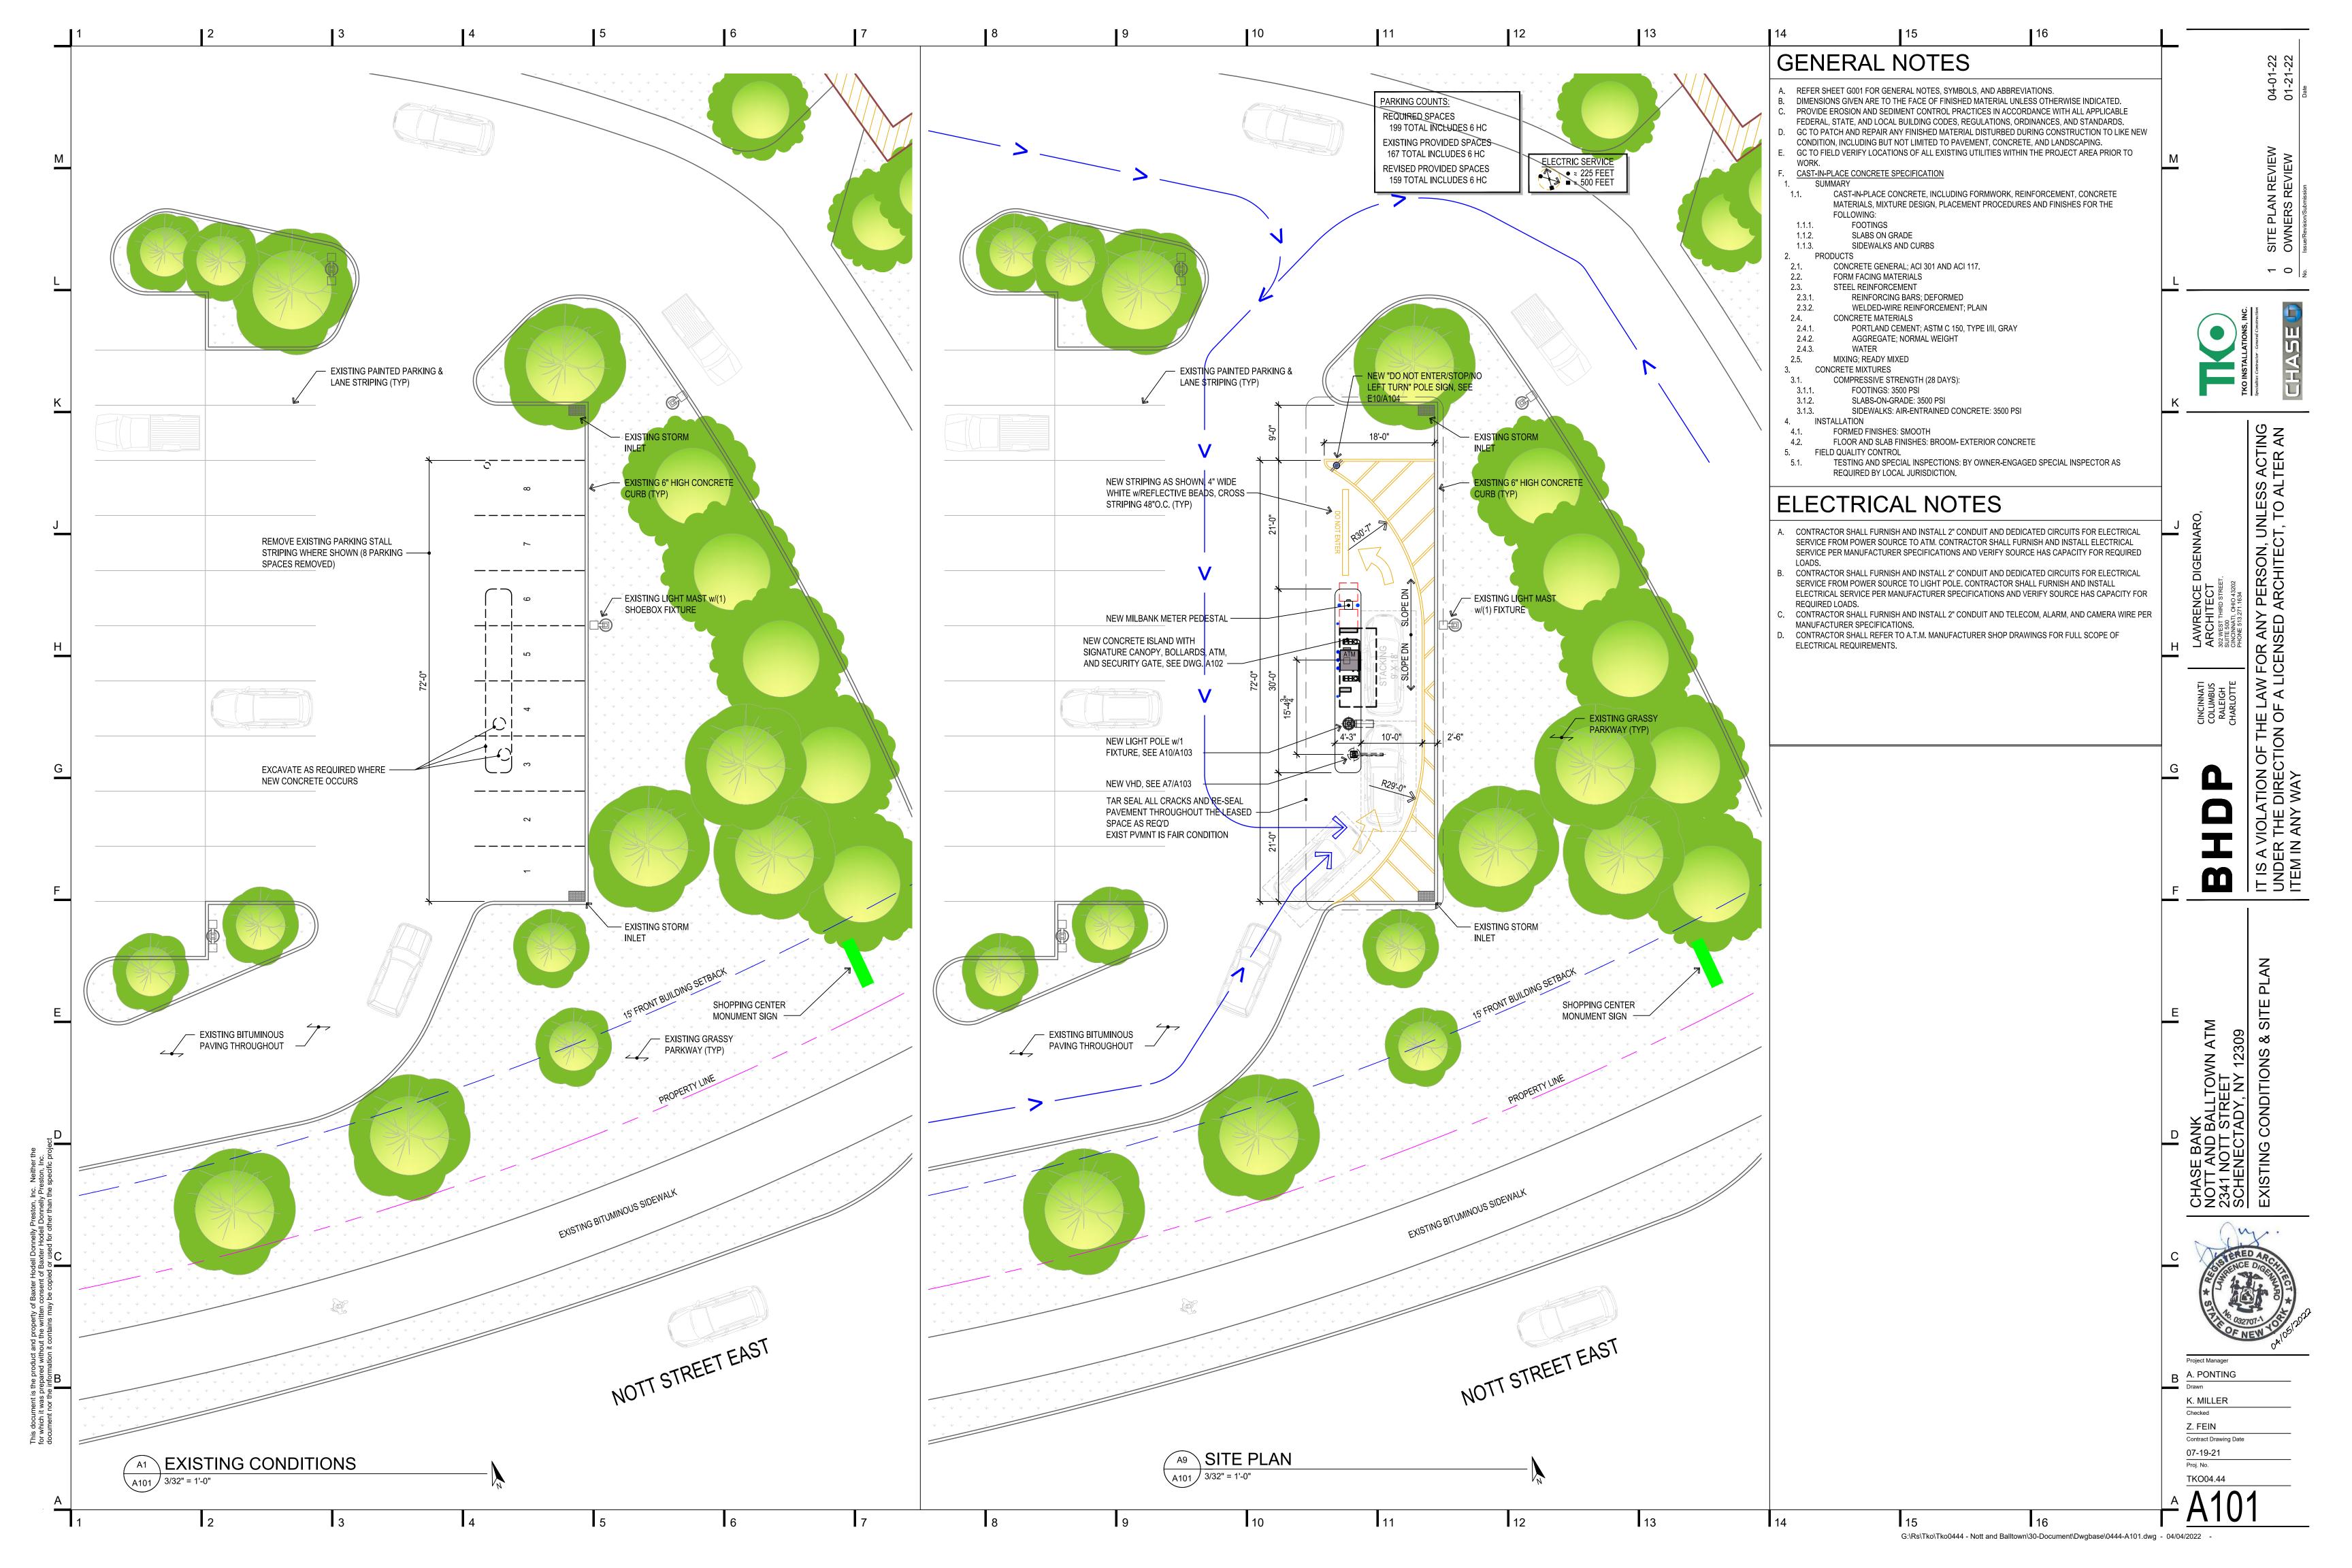Daniel Brennan, Starbucks permit agent, submitted an Application for Site Plan Review for internal and external remodeling of the Starbucks at 2303 Nott St. E. The remodeling includes general painting and interior remodeling, relocating new exterior menu boards and new signage.

The property falls within the C-N Neighborhood Commercial zoning district and Town Center Overlay district. Sections 220-10E (3) (d) and 220-13, Schedule I-D of the Niskayuna zoning code, do not allow restaurants with vehicle pick-up and ordering facilities in the C-N district. However, the Zoning Board of Appeals (ZBA) granted a use variance on November 28, 2012 allowing the restaurant with its present vehicle pick-up and ordering configuration.

Summary of Action Requested by the Planning Board

- A waiver for a façade sign with a sign area of 100% logo is requested as noted in 5, below.
- A waiver allowing two façade signs on one façade is requested as noted in 7, below.
- A waiver of 1.18 sq. ft. of sign area is requested for the Side Entry façade as noted in 7, below.

BACKGROUND INFORMATION

Documentation Package

A completed site plan application and 24-page documentation package was provided that includes the following.

Pages 1 – 9 of the 24 page package

- Entitled Niskayuna Shoprite Sq.
- By Bergman Architects Engineers Planners, Philadelphia, PA

No.	Name	Sheet #	Issue Date	Rev.	Rev Date
1	Demo floor plan	D101	2/14/22	1	4/12/22
2	Demo elevations	D103	2/14/22	1	4/12/22
3	Ref site plan	A001	2/14/22	1	4/12/22
4	Site details	A002	2/14/22		
5	Site details	A003	2/14/22		
6	Site details	A004	2/14/22		
7	Bldg. exterior elevation	A201	2/14/22	1	4/12/22
8	Schedules	A601	2/14/22		
9	FF & E plan	I101	2/14/22	1	4/12/22

The originally issued versions of the drawings identified as numbers 1, 2, 3, 7 & 9 in the table above included proposed modifications to the existing building that were removed from the project scope with Rev. 1 dated 4/12/22. The areas of the building where these proposed modifications were to occur are identified on the Rev. 1 drawings with scalloped red balloons.

Pages 10 – 24 of the 24 page package

- Entitled Starbucks Coffee #7363
- 2303 Nott St. E., Niskayuna, NY 12309
- By Hilton Displays, Greenville, SC
- All drawings contain a "Dwg. Date" of 3/1/22
- All drawings contain a "Rev. Date / Revision" of 4/21/22

All pages of the Hilton Displays drawing package were reviewed relative to Niskayuna zoning code resulting in the following.

1. Site Plan: Demo

- --- Page 11 of the 24 page documentation package
- --- Items A E will be removed from the store and will be replaced with items F L, as shown

2. Site Plan: Proposed

- --- Page 12 of 24
- --- Items identified as F, G, H, I, J, K, L are proposed to be added to the project site

3. Elevation: Existing

- --- Page 13 of 24
- --- Displays the Rear Elevation & Front Elevation
- --- Displays the (1) existing sign on the Rear façade of the building
- --- Displays the (1) existing sign on the Front façade of the building

4. Elevation: Proposed - Drive-Thru

- --- Page 14 of 24
- --- Displays the Exterior Elevation Drive-Thru

--- Displays "Drive Thru" façade sign "L" 48" DT Wall Sign" which is compliant with zoning code

5. <u>Elevation: Proposed – Main Entry</u>

- --- Page 15 of 24
- --- Displays the Exterior Elevation Main Entry
- --- Displays "Logo" façade sign "K" 60" Siren
- --- Section 220 48.4 E (5) Logo of the zoning code states: "In the event that a picture logo is displayed on a sign, it shall be incorporated into the permitted sign are to comprise not more than 30% of the sign area..."
- --- As proposed the logo comprises 100% of the sign & requires a waiver
- --- A waiver of 70% of logo area is requested resulting in a façade sign with an area of 100% logo

6. Elevation: Proposed -- Rear

- --- Page 16 of 24
- --- Displays the Exterior Elevation Rear
- --- Displays "Starbucks" façade sign "J 16" Remote Channel Letters"
- --- The proposed sign is complaint with zoning code

7. Elevation: Proposed -- Side Entry

- --- Page 17 of 24
- --- Displays the Exterior Elevation Side Entry
- --- Section 220-48.4 E (9) Number of signs of the zoning code states: "A maximum of one facade sign per use is permitted, except that a use fronting on two streets may have one sign for each building front..."
- --- As proposed the side entry will have two façade signs on one façade & will require a waiver
- --- A waiver is requested for two façade signs on the "Side Entry" elevation
- --- Schedule I-D Part 1 C-N District states: "For each linear foot of building frontage, 1 square foot of sign area shall be permitted...."
- --- The Side Entry façade measures 22.96 ft.
- --- As proposed the two signs measure 24.14 sq. ft. (17.18 sq. ft. + 6.96 sq. ft.)
- --- A waiver is requested for 1.18 sq. of sign area.

8. 3-Panel Menu -- Freestanding

- --- Page 18 of 24
- --- Displays the DTE Menu 3 Panel Freestanding
- --- There is no specific section of the Niskayuna zoning code related to menu panels
- --- The Planning Board should review the menu panels as part of the overall redesign

9. DOS ON Canopy – DCB On Unistrut

- --- Page 19 of 24
- --- Displays DTE canopy and associated control boxes
- --- There is no specific section of the Niskayuna zoning code related to this item
- --- The Planning Board should review the canopy as part of the overall redesign

10. Pre-Menu Board - Freestanding

- --- Page 20 of 24
- --- Displays the DTE Pre-menu freestanding
- --- There is no specific section of the Niskayuna zoning code related to menu panels

--- The Planning Board should review the menu panels as part of the overall redesign

11. Revolution Clearance Bar

- --- Page 21 of 24
- --- Displays the drive-thru clearance bar and mounting
- --- There is no specific section of the Niskayuna zoning code related to clearance bars
- --- The Planning Board should review the clearance bar as part of the overall redesign

12. 16" Channel Letter - Remote "STARBUCKS" sign

- --- Page 22 of 24
- --- Displays the "Starbucks" façade sign identified as "J" on the site plan and drawing set
- --- The sign measures 154.63" long x 16" high (17.18 sq. ft.) and is compliant with code

13. 60" Illuminated Siren – Starbucks logo sign

- --- Page 23 of 24
- --- Displays the Starbucks logo sign identified as "K" on the site plan and drawing set
- --- Per Niskayuna zoning code the area of the sign is 60" x 60" or 25 sq. ft.
- --- As proposed the logo comprises more than 30% of the sign area and therefore requires a waiver from the PB as noted in 5, above

14. 48" DT Wall Sign – RH – Drive-Thru sign

- --- Page 24 of 24
- --- Displays the Drive-Thru sign identified as "L" on the site plan and drawing set
- --- The sign measures 47.75" wide x 21" high (6.96 sq. ft.)
- --- As proposed the sign is individually compliant with zoning code

The applicant is appearing before the Planning Board this evening to present the proposed redesign and address any questions that arise.




TOWN OF NISKAYUNA

One Niskayuna Circle Niskayuna, New York 12309-4381

Phone: (518) 386-4530

Application for Site Plan Review

Applicant (Owner or Agent):	Location:
DANIEL BRENNAN - Name <u>STARBUCKS PERMIT AGENT</u>	Number & Street 2303 NOTT ST E
Address 8 STONEGATE LANE,	Section-Block-Lot <u>40.</u> - 1 - 17.3
SALEM NH 03079	
Email DPBPERMITS@GMAIL.COM	
Telephone 603-505-5633 Fax	Zoning District C-N Neighborhood Commercia
Proposal Description: STABUCKS REN	OVATION- EXTERIOR WORK TO INCLUDE:
REMOVE EXISTING WALL SIGNAGE AND IN	
EXISTING CANOPIES (2) MAIN ENTRANCE A	ND ONE OVER DRIVE THRU WINDOW
UPDATE PATIO FURNITURE. RELOCATE AN	ND UPDATE DRIVE THRU EQUIPMENT
CLEARANCE BAR, PRE-MENU BOARD, ORDER	SCREEN WITH CANOPY AND 3 PANEL
MENU BOARD	
Signature of applicant:	Date: 04/25/22
Signature of owner (if different from applicant)	: Pult Worth
Date: 4/27/22	

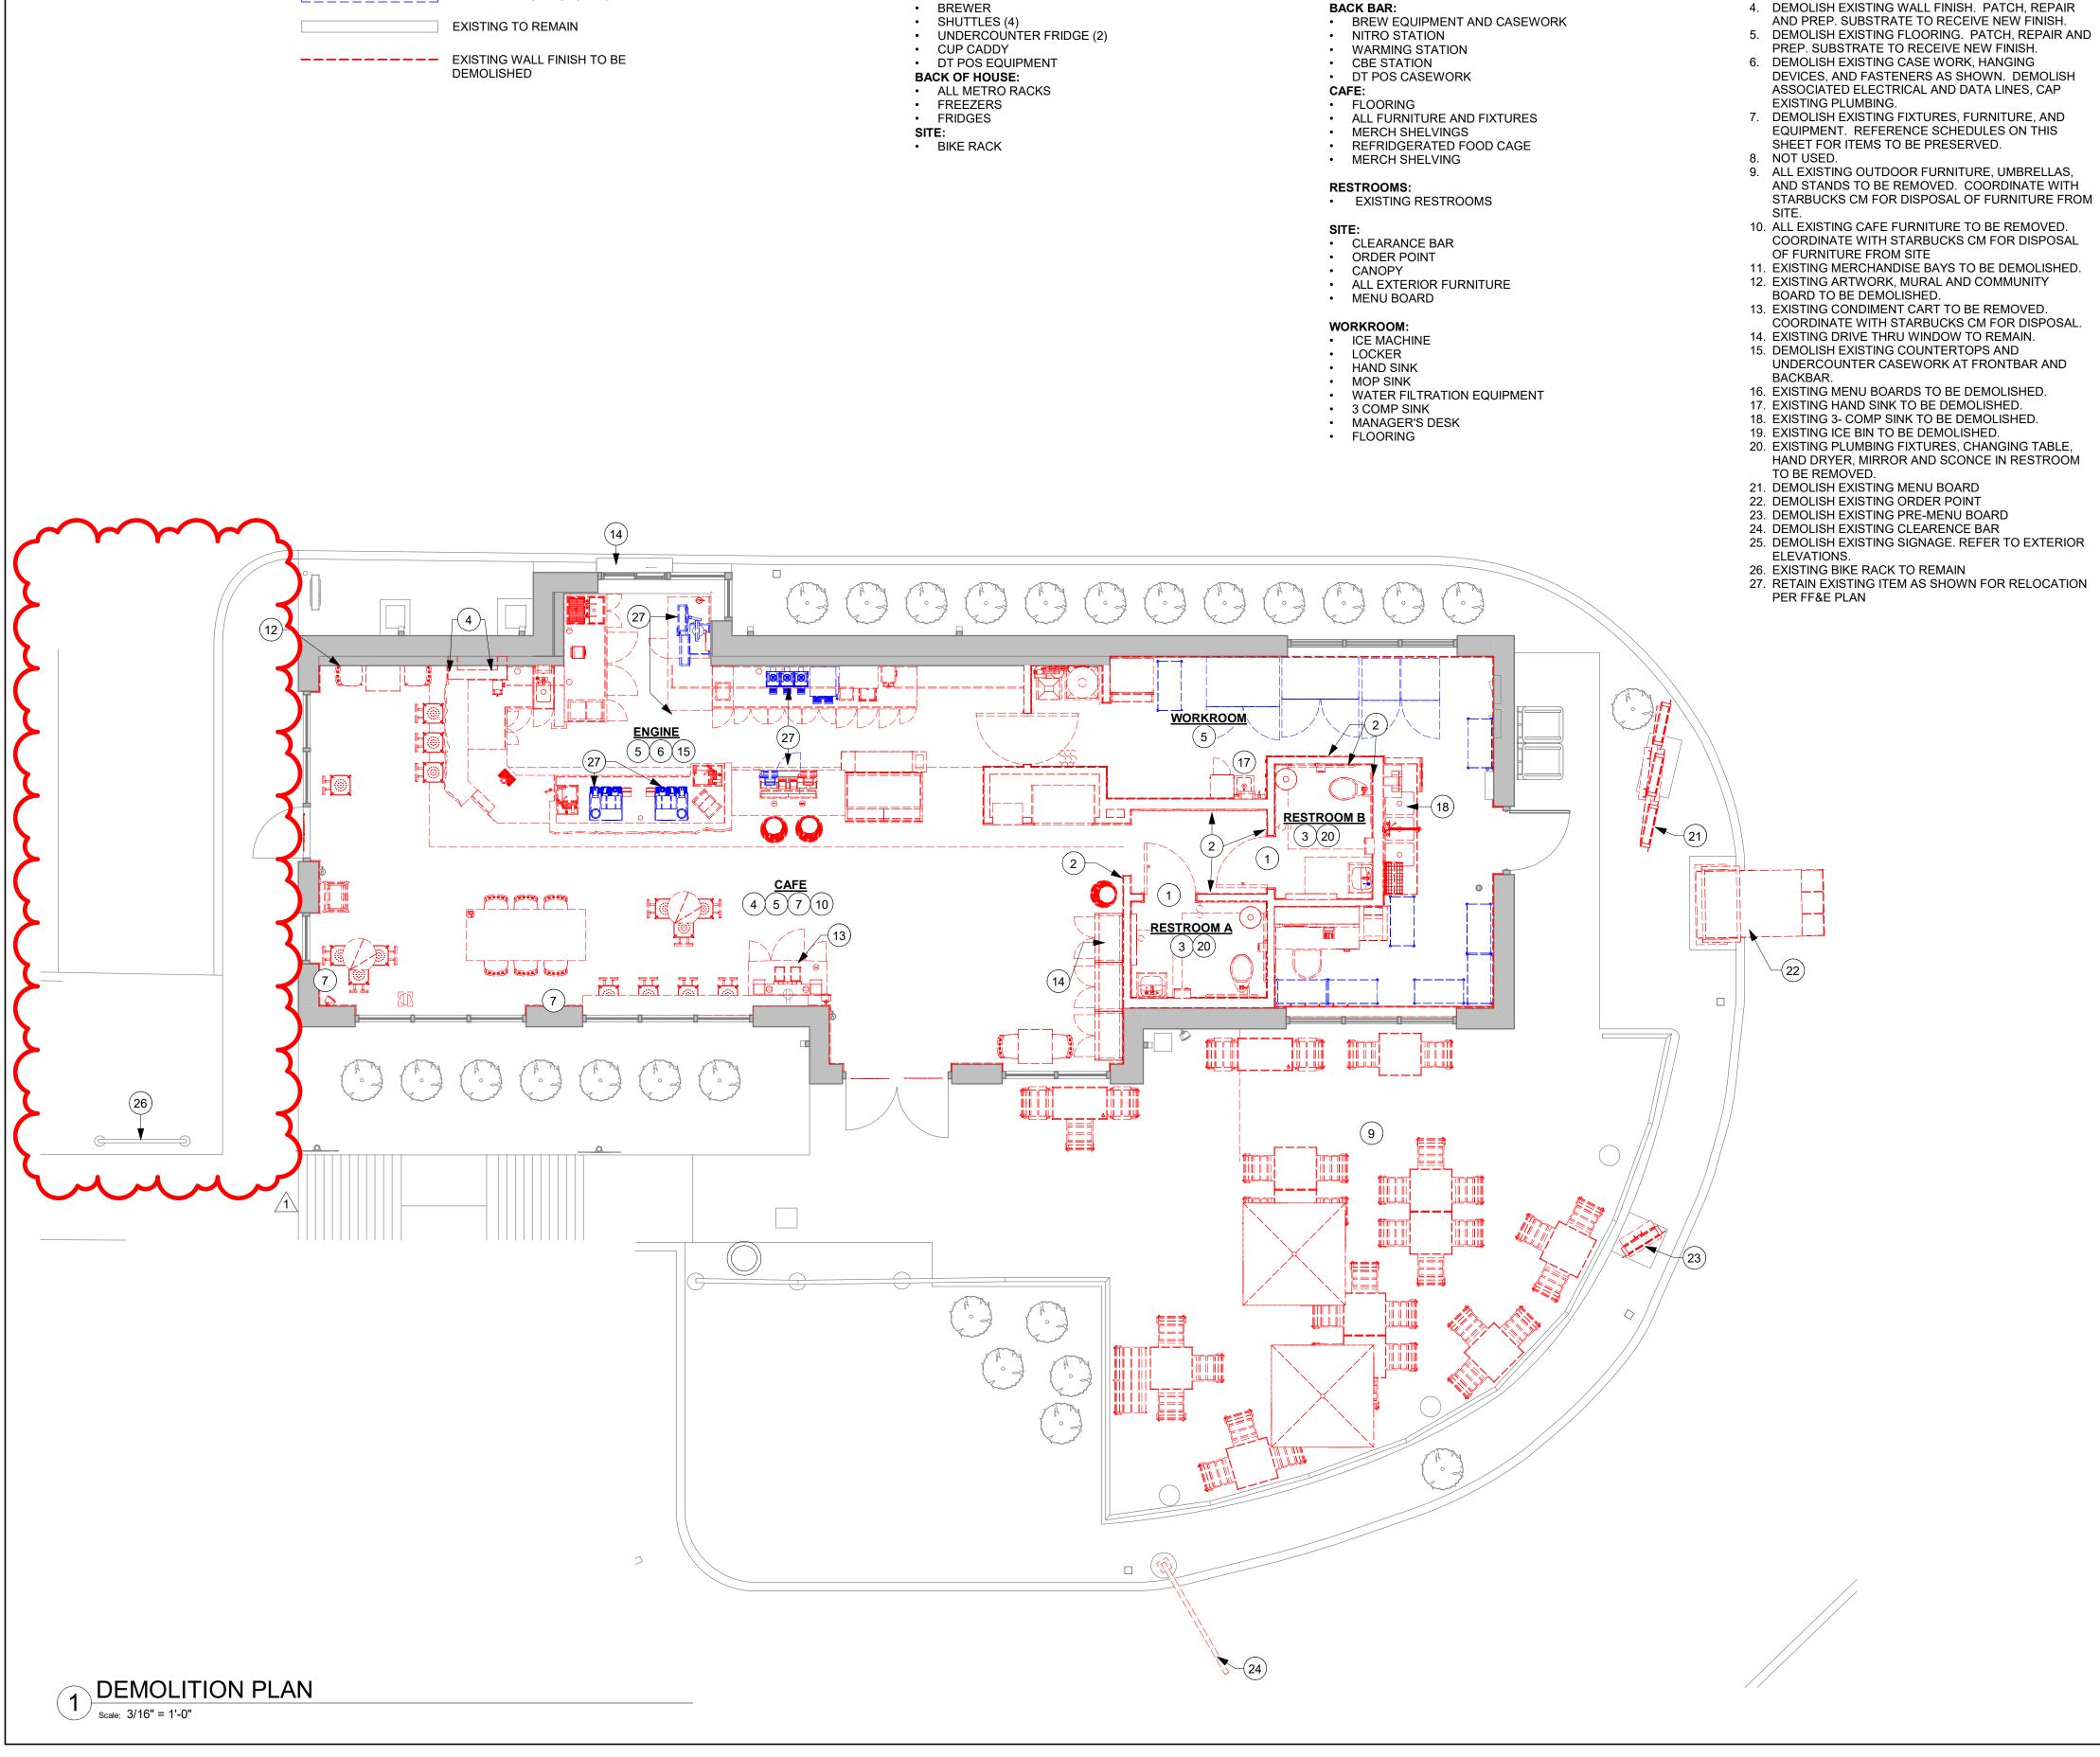

ITEMS TO PRESERVE

UNDERCOUNTER FRIDGES (2)

FRONT BAR:

SAFE

BACK BAR:

MAESTRO'S (2)

POS PRINTER

LEGEND

MATERIAL TO BE DEMOLISHED

PRESERVE FOR FUTURE USE

EXISTING WALL TO REMAIN

ITEMS TO DEMOLISH

ESP ICE BIN, SINKS, AND CASEWORK

FRONT BAR:

ZEPHYR

POS (2)

POS CASEWORK

GENERAL NOTES

KEYED NOTES

UNDERSIDE OF STRUCTURE.

FASTENERS.

PLUMBING.

1. DEMOLISH EXISTING DOOR FRAME AND ASSOCIATED

2. DEMOLISH INTERIOR PARTITION FROM FLOOR TO

3. DEMOLISH EXISTING RESTROOMS AND CAP

- A. IF DURING DEMOLITION CONDITIONS ARE REVEALED THAT MAY JEOPARDIZE INTEGRITY OF STRUCTURE OR PRECLUDE FOLLOWING DESIGN INTENT, GENERAL CONTRACTOR TO NOTIFY STARBUCKS CONSTRUCTION MANAGER IMMEDIATELY.
- B. GENERAL CONTRACTOR IS RESPONSIBLE FOR SITE INVESTIGATION PRIOR TO DEMOLITION TO REVEAL FULL SCOPE OF WORK. NOTIFY STARBUCKS CONSTRUCTION MANAGER IF EXISTING CONDITIONS DEVIATE FROM CONSTRUCTION DOCUMENTS.
- C. REMOVE EXISTING INTERIOR WALL FINISH AS SHOWN. PATCH, REPAIR AND PREP. SUBSTRATE TO RECEIVE NEW FINISH. REMOVE WALL COVERINGS ON EXISTING WALLS TO REMAIN THAT FACE AREAS OF DEMOLITION. REMOVAL SHALL INCLUDE ANY RESIDUAL MATERIAL AFTER DEMOLITION, (I.E. PIECES OF WALL COVERING OR BACKING). REMOVAL OF ALL COVERINGS IS TO BE DONE W/O DAMAGING THE EXISTING WALL SURFACE TO REMAIN. ALSO REMOVE WALL DEVICES AND ITEMS MOUNTED TO WALLS.
- D. REMOVE EXISTING FLOORING AS SHOWN. PATCH, REPAIR AND PREP. SUBSTRATE TO RECEIVE NEW FINISH. REMOVAL OF EXISTING FLOORING INCLUDES, BUT IS NOT LIMITED TO REMOVAL OF EXISTING CERAMIC TILE, CARPET OR VINYL TILE FLOORING AND ASSOCIATED WALL BASE. SUBFLOOR TO BE STRIPPED OF ALL COVERING/FINISH AND CLEANED TO REMOVE EXISTING ADHESIVE, GROUT, MORTAR, DIRT AND COATINGS. FINAL SURFACE TO BE STREAK-FREE WITH NO MACHINE MARKS AND/OR SMOOTH, STABLE AND LEVEL. PROVIDE LEVELING WHERE NECESSARY TO ACCOMMODATE NEW FINISHES.
- E. DEMOLITION PLANS REPRESENT APPROXIMATE LOCATION OF EXISTING WALLS TO BE DEMOLISHED. FIELD VERIFY TYPE OF CONSTRUCTION AND HEIGHT OF WALLS. PLANS DO NOT NECESSARILY INDICATE ALL DEMO WALLS, COUNTERS, HANDRAILS, WALL PROTECTION, CLOSETS, SINKS ETC. PRIOR TO DEMOLITION, FIELD VERIFY THAT WALLS TO BE REMOVED DO NOT PROVIDE SUPPORT FOR EXISTING BUILDING ELEMENTS AND EXISTING CONSTRUCTION TO REMAIN. NOTIFY STARBUCKS CONSTRUCTION MANAGER IF DEMOLITION WALLS SUPPORT EXISTING BUILDING ELEMENTS.
- F. DEMOLISH AND REMOVE DOORS, VINYL BASE, CONDUIT, WIRING, DUPLEXES, DATA OUTLETS, CABLES, SHELVING, METAL STUD AND GYPSUM BOARD WALLS, CLOSETS, CABINETS, FILES, COUNTERS, WOOD MOLDING, SHELVES AND ENCLOSURES WHERE APPLICABLE.
- G. VERIFY WITH STARBUCKS CONSTRUCTION MANAGER ACCESS TO THE DEMOLITION AREA, INGRESS AND EGRESS ROUTES FOR MATERIAL AND EQUIPMENT.
- H. PROTECT EXISTING FLOORS, WALLS AND CORNERS TO REMAIN ALONG WORK ACCESS ROUTES.
- I. CONTAIN DUST AND DEBRIS WITHIN THE DEMOLITION AREA.
- J. THE GENERAL CONTRACTOR SHALL PERFORM WORK IN A MANNER THAT DOES NOT DAMAGE THE EXISTING STRUCTURE. DEMOLITION SHALL NOT COMPROMISE THE STRUCTURAL INTEGRITY OF ANY WALLS, FLOORS, CEILINGS, SUPPORTS, STRUCTURE, ETC. TO REMAIN.
- K. ALL DEMOLITION MATERIALS AND DEBRIS SHALL BE DISPOSED OF ACCORDING TO FEDERAL, STATE AND LOCAL REGULATIONS.
- L. AT LOCATIONS WHERE EXISTING WALLS ARE TO BE REMOVED NEAR EXISTING WALLS TO REMAIN, PERFORM DEMOLITION WITHOUT DISTURBING EXISTING ELEMENTS TO REMAIN. WALLS TO REMAIN SHALL BE INTACT AND HAVE A NEAT SURFACE.
- M. REFER TO "ITEMS TO BE PRESERVED" LIST FOR ITEMS THAT SHALL BE SALVAGED FOR RELOCATION. VERIFY WITH OWNER FOR ON SITE STORAGE LOCATION OF SALVAGED ITEMS.
- N. DAMAGED FIREPROOFING SHALL BE REPAIRED/ REPLACED TO MATCH EXISTING.
- O. THE GENERAL CONTRACTOR SHALL DEMOLISH ANY EXISTING ABANDONED VOICE/DATA CABLING AND DEAD OR NON-USE ELECTRICAL BACK TO PANEL. ALL RECEPTACLES NOT REUSED ARE TO BE REMOVED, PATCHED AND PAINTED.
- P. REMOVAL OF LOW VOLTAGE EQUIPMENT, PERTAINING TO DATA/COMMUNICATIONS AND TELEPHONE SHALL BE VERIFIED BY THE STARBUCKS CONSTRUCTION MANAGER PRIOR TO REMOVAL. SALVAGED EQUIPMENT SHALL BE STORED IN A CLIMATE CONTROLLED ENVIRONMENT FOR FUTURE INSTALLATION.
- Q. LABEL ALL ITEMS AND PROPERLY STORE FOR RE-INSTALL.
- R. REMOVE EXISTING PLUMBING FIXTURES AND HVAC EQUIPMENT AS NECESSARY. CAP LINES AND TERMINATE DUCTS AS NECESSARY FOR THOSE NOT BEING RE-USED.



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LICENSE NO: 029335
EXPIRATION DATE: 07/31/2023

PROJECT NAME:
VISKAYUNA

PROJECT ADDRESS: 2303 NOTT STREET EA

STORE #: 07363 PROJECT #: 03364-075

ISSUE DATE: 02/14/2022
DESIGN MANAGER: NATALIA ROSENTHAL
PRODUCTION DESIGNER: MB/EE
CHECKED BY: HVT

Revision Schedule			
)	Ву	Description	
22		REVISIONS TO SITE SCO	

SHEET TITLE:
DEMOLITION FLOOR
PLAN

SCALE: AS SHOWN
SHEET NUMBER:

D101

13/2022 8:35:43 AM

ITEMS TO DEMOLISH SIGNAGE RESERVE BAR VINYL **KEYED NOTES** 1. DEMLOSIH EXISTING SIGNAGE DEMOLISH EXISTING VINYL 3.) NOT USED

LEGEND MATERIAL TO BE DEMOLISHED EXISTING WALL TO REMAIN PRESERVE FOR FUTURE USE EXISTING TO REMAIN

---- EXISTING WALL FINISH TO BE DEMOLISHED

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STORE #: PROJECT #:

07363 03364-075


02/14/2022 NATALIA ROSENTHAL ISSUE DATE: DESIGN MANAGER: PRODUCTION DESIGNER: MB/EE CHECKED BY:

Revision Schedule REVISIONS TO SITE SCOPE

SHEET TITLE: DEMOLITION ELEVATIONS SCALE: AS SHOWN

SHEET NUMBER:

D103

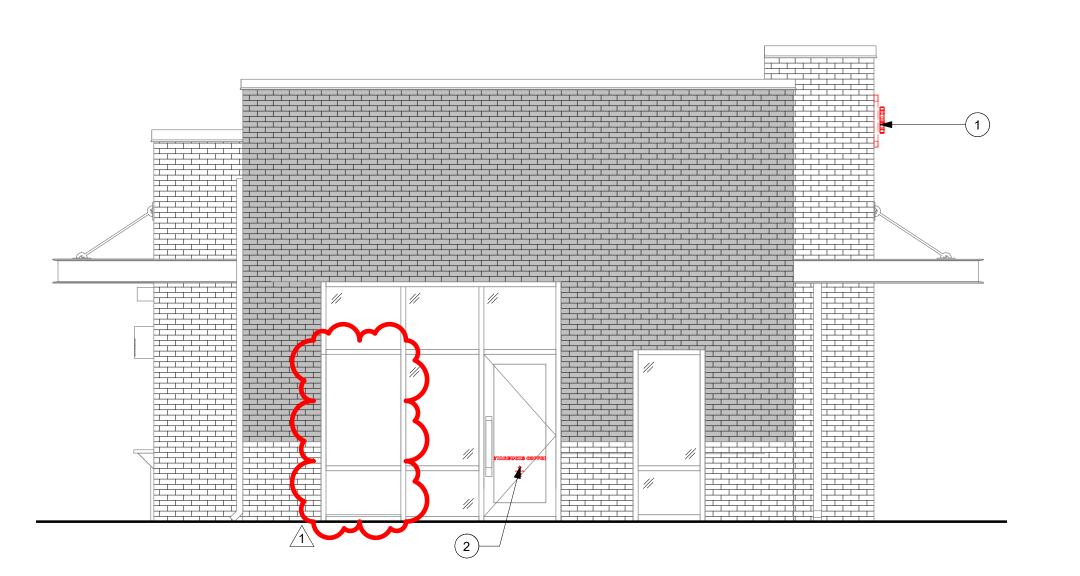


2 EXTERIOR ELEVATION - SIDE ENTRY EXTERIOR ELEVATION - REAR

EXTERIOR ELEVATION - MAIN ENTRY

		SITE SCHEDULE	- "Y"	
DESIGN ID	COUNT	DESCRIPTION	RESP.	COMMENTS
EXTERIOR N	/IENU			
22541	1	MENU BOARD - DT 3 PANEL SQUARE FRAME FREESTANDING - 63X62IN 1600X1575MM - BLACK	SB/SB	
22546	2	MENU BOARD - DT DIGITAL ORDER SCREEN WITH POST - BLACK	SB/SB	
OTHER				
14103	1	BOLLARD NONILLUMINATED SQUARE - FLAT BLACK MT0028	SB/GC	
22543	1	DT ORDER POINT CANOPY SQUARE FRAME - BLACK	SB/SB	
X0011	1	VEHICLE LOOP DETECTION	SB/GC	BY HME; CONDUIT MUST BE INSTALLED PRIOR TO PAVING; GC TO COORDINATE WITH PAVING CONTRACTOR
UMBRELLA				·
10068	2	UMBRELLA - IN GROUND - 6FT 183CM - GREEN CANVAS WITH STARBUCKS WORDMARK F0056	SB/GC	
18714	2	UMBRELLA - BASE 200LB 90KG - FLAT BLACK MT0028	SB/GC	

		EXTERIOR SIGNAGE SCHE	DULE - "S"	
DESIGN ID	COUNT	DESCRIPTION	RESP.	COMMENTS
SIGNAGE - I	DISK		•	·
13164	1	SIGN - DISK SF ILLUMINATED FLUSH MOUNTED EVOLVED - 60IN 1525MM	SB/SB	MOUNTED TO EXISTING WALL- SIGN VENDOR TO COORDINATE DETAILS WITH STARBUCKS DESIGN
SIGNAGE - I	ORIVE THRU	j		
14099	2	SIGN - DRIVE THRU ILLUMINATED ARROW SERIES FLUSH MOUNTED - RH - 48IN 1220MM	SB/SB	MOUNTED TO EXISTING WALL- SIGN VENDOR TO COORDINATE DETAILS WITH STARBUCKS DESIGN
22544	1	SIGN - DT CLEARANCE BAR SQUARE FRAME FREESTANDING - BLACK AND DARK GREEN	SB/SB	
SIGNAGE - \	NORDMAR	<		
18496	2	SIGN - WORDMARK STARBUCKS FLUSH MOUNTED - 16IN 405MM	SB/SB	MOUNTED TO EXISTING WALL - SIGN VENDOR TO COORDINATE DETAILS WITH STARBUCK DESIGN

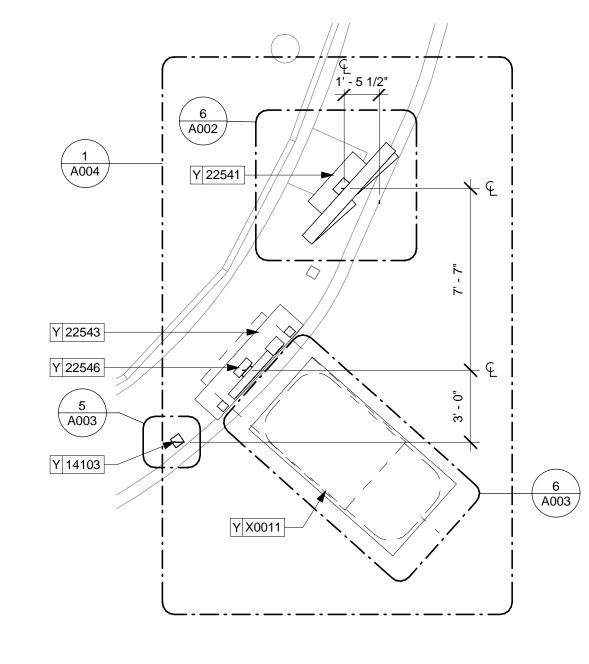

2 ENLARGED PLAN AT ORDERPOINT
Scale: 1/4" = 1'-0"

GENERAL NOTES

- REFER TO EXTERIOR ELEVATIONS ON SHEET A201 FOR BUILDING SIGNAGE LOCATION AND DESIGN ID. REFER TO ELECTRICAL PLANS FOR ELECTRICAL REQUIREMENTS.
- B. LANDSCAPING TO BE PROVIDED PER ZONING CODE AND SUSTAINABILITY REQUIREMENTS.
- C. DRIVE-THRU EQUIPMENT INCLUDING VEHICLE DETECTION LOOP, WIRELESS COMMUNICATION AND MONITORS SHALL BE COORDINATED BY STARBUCKS CONSTRUCTION MANAGER. REFER TO ELECTRICAL PRAWINGS FOR ADDITIONAL REQUIREMENTS.

- E. GENERAL CONTRACTOR TO APPLY CONCRETE SEALER TO ALL EXTERIOR CONCRETE PATIO AND WALKWAY SURFACES.
- F. GENERAL CONTRACTOR TO VERIFY ALL EXISTING ELEVATIONS AND BUILDING CONDITIONS IN FIELD PRIOR TO START OF CONSTRUCTION.
- G. PROVIDE DETECTABLE WARNING (IF APPLCABLE PER LOCAL CODE) AT TRANSITION FROM SIDEWALK TO DRIVE AISLE.
- H. ACCESSIBLE PARKING SPACES AND ACCESS AISLES SHALL HAVE SURFACE SLOPE NOT TO EXCEED 2% IN ALL DIRECTIONS.
- REFER TO ELECTRICAL DRAWINGS FOR SITE RELATED ELECTRICAL SLOPE.
- SCRAPE AND REPAINT ALL EXISTING PAINTED SITE FEATURES, INCLUDING, BUT NOT LIMITED TO CURBS, BOLLARDS, RAILINGS AND SITE LIGHTING BASES.
- K. SEE SHEET A002-A005 FOR ARCHITECTURAL SITE DETAILS.

KEYED NOTES

- 1. EXISTING STRIPING.
- 2. EXISTING ADA PARKING.
- 3. EXISTING WAYFINDING ARROWS.
- 4. EXISTING LANDSCAPED AREA. 5. ACCESSIBLE PATH OF TRAVEL TO PUBLIC WAY.
- 6. EXISTING CANOPY ABOVE SHOWN DASHED FOR REFERENCE.
- EXISTING OUTDOOR SEATING AREA.
- 8. EXISTING BIKE RACK TO REMAIN.
- EXISTING BOLLARD. 10. EXISTING TRASH ENCLOSURE.
- 11. EXISTING SITE LIGHTING. 12. EXISTING METAL RAILING.
- 13. EXISTING "DRIVE THRU" DIRECTION SIGNAGE. 14. EXISTING "THANK YOU/EXIT ONLY" SIGNAGE.
- 15. NEW FLUSH MOUNTED BUILDING SIGNAGE. SEE ELEVATIONS.SCHEDULES FOR DETAILS.
- M. NEW ORDER POINT WITH CANOPY. SEE SCHEDULES FOR
- DETAILS. LANDLORD TO FURNISH AND INSTALL CONCRETE FOOTINGS AND ELECTRICAL CONDUIT.
- 18. NEW PRE MENU BOARD. SEE SCHEDULES FOR DETAILS. LANDLORD TO FURNISH AND INSTALL CONCRETE
- FOOTINGS AND ELECTRICAL CONDUIT. 19. NEW CLEARANCE BAR. SEE SCHEDULES FOR DETAILS.
- LANDLORD TO FURNISH AND INSTALL CONCRETE FOOTINGS AND ELECTRICAL CONDUIT
- 20. EXISTING DRIVE THRU WINDOW.
- 21. EXISTING DRAIN.
- 22. EXISTING TRANSFORMER.
- 23. EXISTING ELECTRICAL METER. 24. LANDSCAPE AREA.
- 25. ACCESSIBLE PATH OF TRAVEL TO PUBLIC WAY.
- 26. NEW CANOPY ABOVE SHOWN DASHED FOR REFERENCE. 27. NEW OUTDOOR SEATING. SEE FF&E PLAN AND
- SCHEDULES. 28. NEW 3-PANEL MENU BOARD. SEE SCHEDULES FOR DETAILS.
- 24 NEW NONILLUMINATED BOLLARD
- 30 NOT USED
- 31. DRIVE THRU DETECTOR LOOP. SEE SITE DETAILS AND SCHEDULE.



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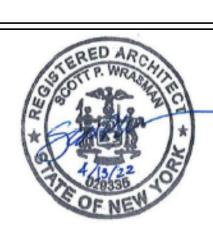
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STORE #: 07363 03364-075

PROJECT #: ISSUE DATE: 02/14/2022 DESIGN MANAGER: NATALIA ROSENTHAL PRODUCTION DESIGNER: MB/EE


	Re	vision Schedule
Date	Ву	Description
04/12/22		REVISIONS TO SITE SCOPE

CHECKED BY:


REFERENCE SITE PLAN

SCALE: AS SHOWN SHEET NUMBER:


A001

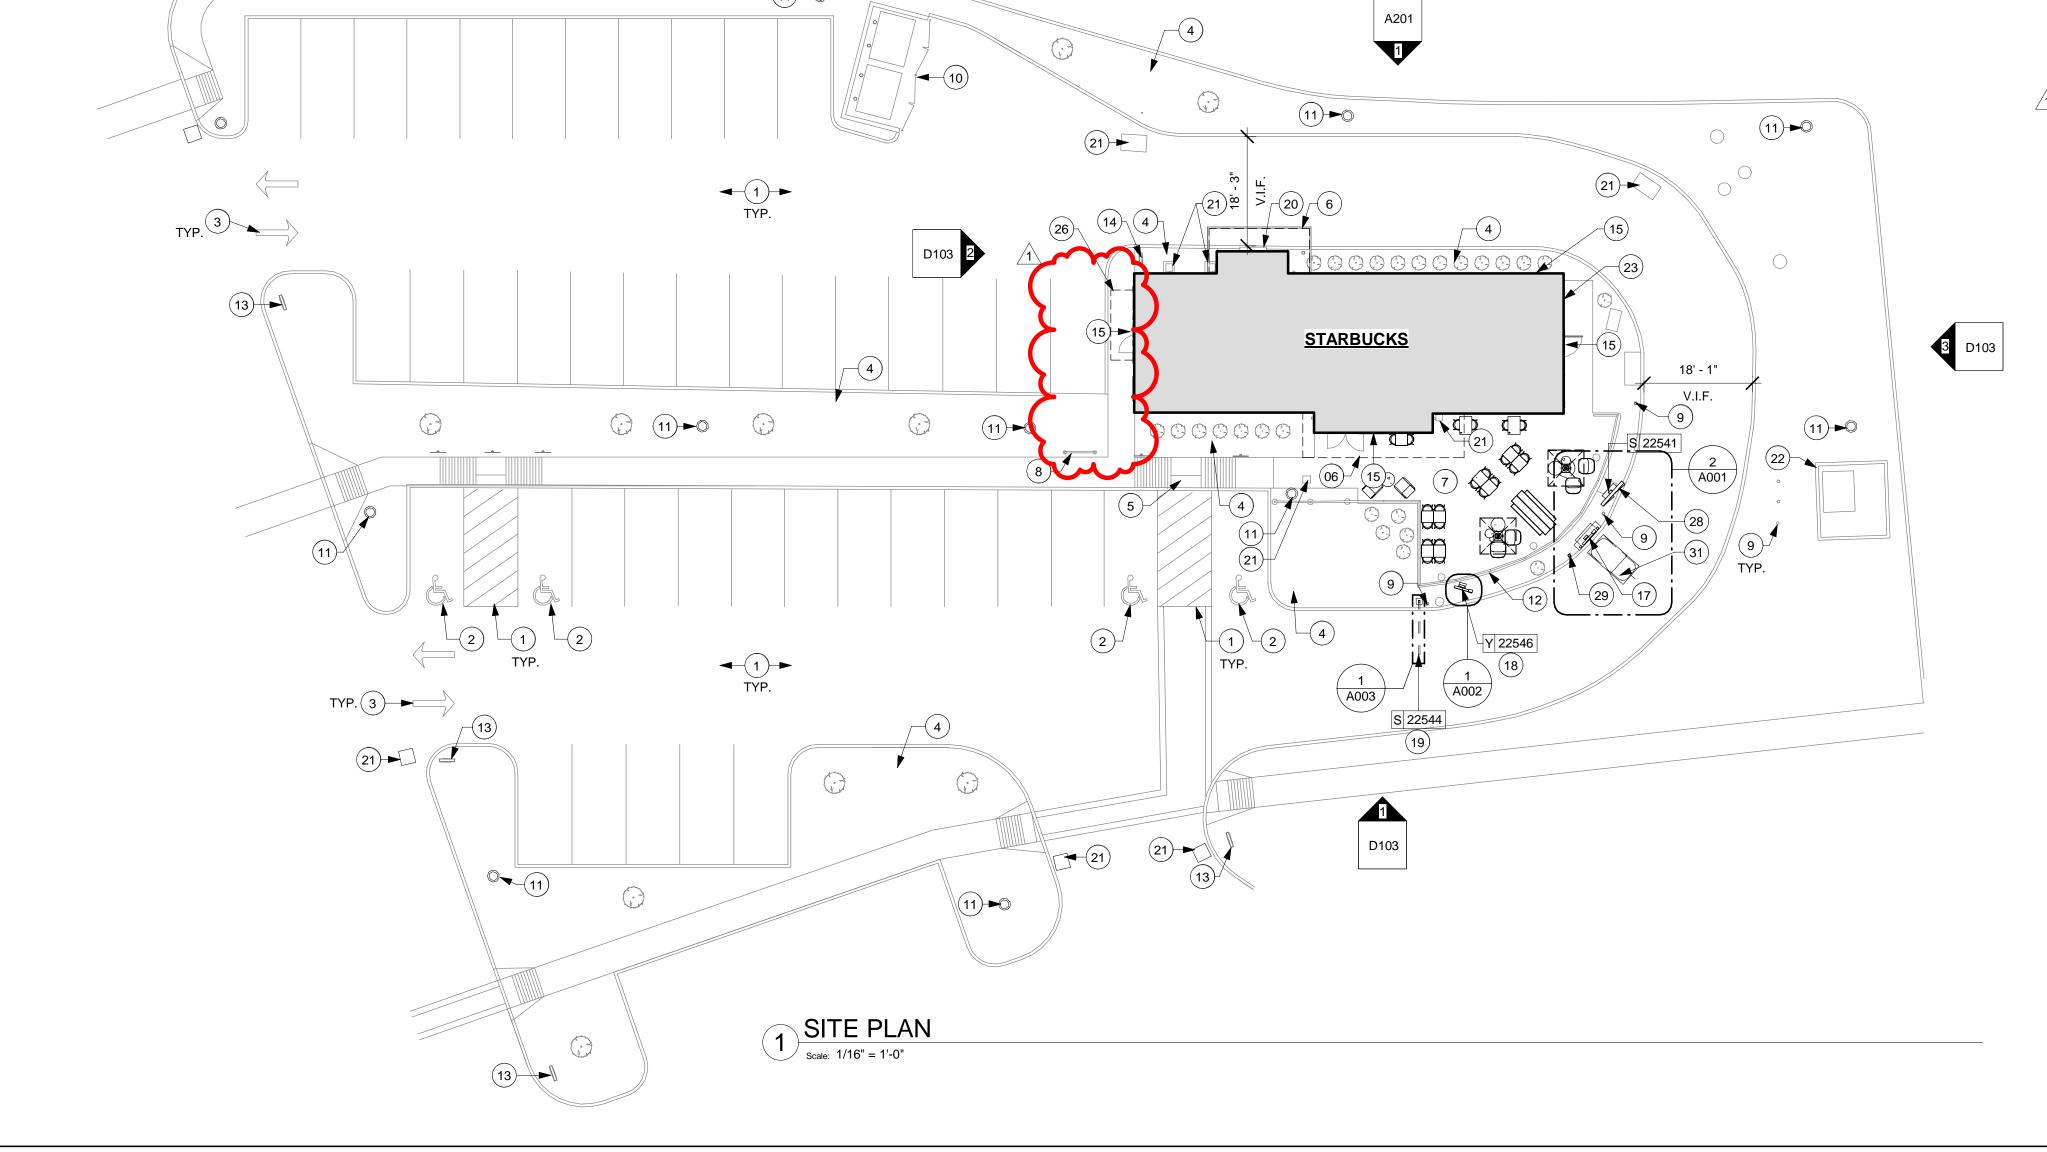

SITE DETAIL DRAWINGS FOR REFERENCE ONLY. SIGN VENDOR TO ENGINEER AND PULL PERMIT FOR SIGNAGE FEATURES.

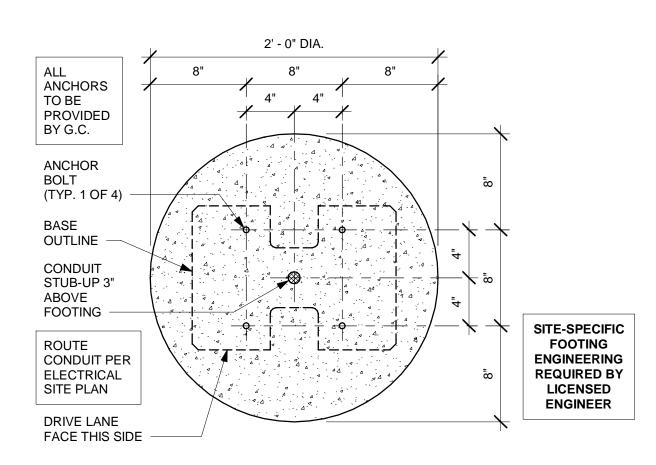

3 DTE PRE-MENU BOLT PATTERN (TOP VIEW)

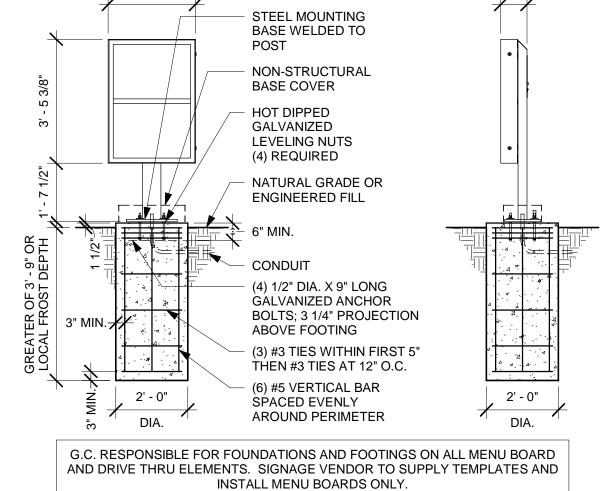

(1) CONDUIT,

RÓUTE TO

PANEL

ELECTRICAL

MENU BOARD

CONCRETE

FOOTING

20'-0" (6M) TO CENTERLINE OF

ORDER CONFIRMATION POST

SITE-SPECIFIC FOOTING ENGINEERING REQUIRED BY LICENSED ENGINEER 2 DTE PRE-MENU GROUND FOOTING

FRONT ELEVATION

EDGE OF CONCRETE CURB -

PRE-MENU 30 DEG

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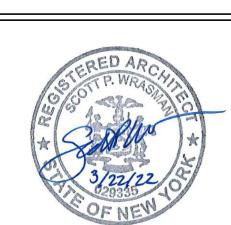
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SIDE ELEVATION

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07363

STORE #: PROJECT #: 03364-075 ISSUE DATE: 02/14/2022

DESIGN MANAGER: NATALIA ROSENTHAL PRODUCTION DESIGNER: MB/EE CHECKED BY:


Revision Schedule Description SHEET TITLE: SITE DETAILS

SCALE: AS SHOWN

SHEET NUMBER:


SEE GROUND FOOTING DETAIL FOR ROD LENGTH **CENTER ANCHOR ROD PATTERN IN FOUNDATION** (3) 1/2" - 13 HEAVY HEX NUTS ALTERNATE ADHESIVE POST-INSTALLED ANCHORS: & WASHER - GALVANIZED HILTI 1/2" DIA. HVU ADHESIVE CAPSULES AT 4" EMBEDMENT WITH A36 HOT-DIPPED GALVANIZED TACK NUT THREADED STEEL RODS AND HARDWARE. (4) REQUIRED TO ROD 1/2" HEAVY HEX (4) 1/2" DIA. X 9" LENGTH A36 THREADED HOT DIPPED NUT WITH WASHER GALVANIZED ANCHOR RODS WITH GALVANIZED HARDWARE SITE-SPECIFIC FOOTING ENGINEERING REQUIRED BY LICENSED ENGINEER


5 DTE PRE-MENU ANCHOR ROD

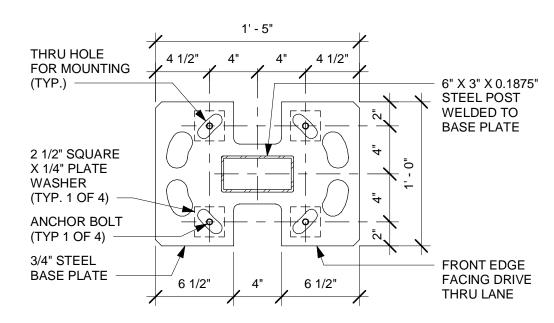


A002

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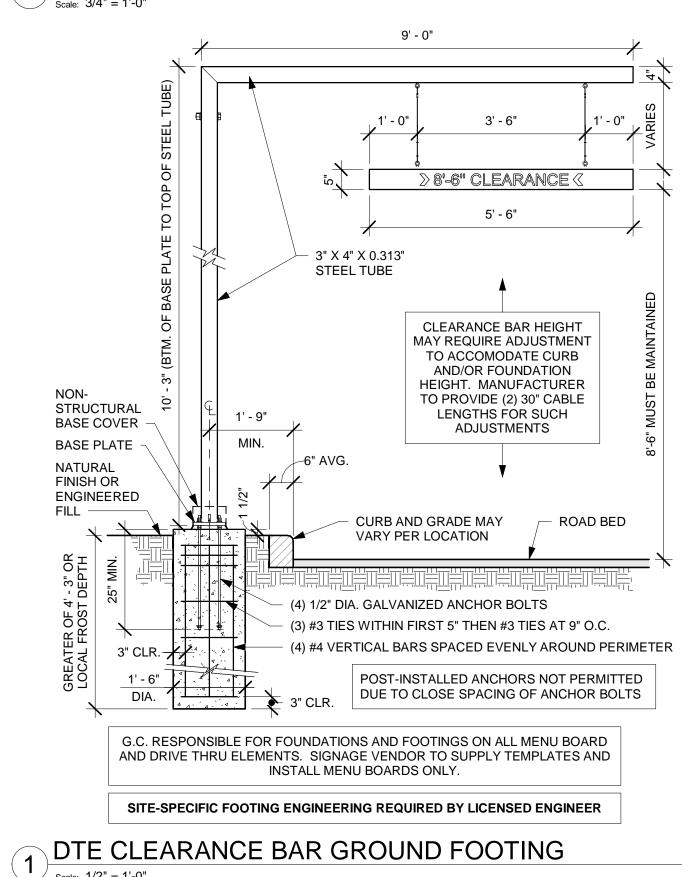


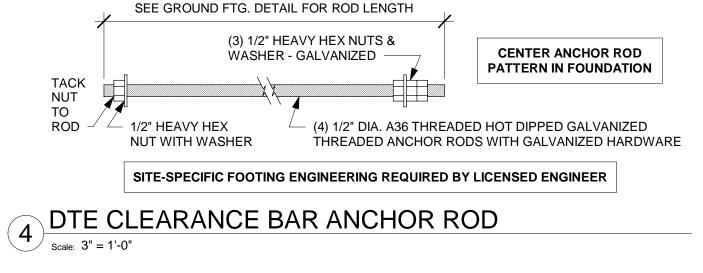3 DTE CLEARANCE BAR BASE PLATE Scale: 1 1/2" = 1'-0"

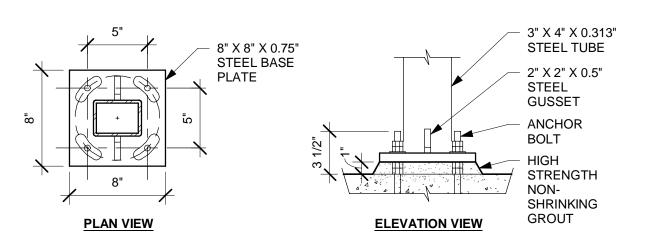


2 DTE CLEARANCE BAR BOLT PATTERN (TOP VIEW)

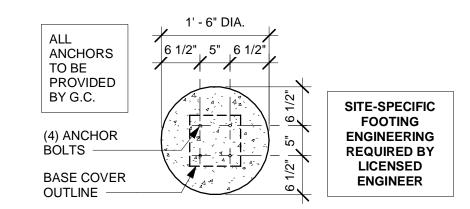Scale: 3/4" = 1'-0"



2. Measure the distance from the curb to the outlet of the conduit that comes from the building to post or menu board. If the distance is greater than two feet, substitute a longer 1/2 inch PVC • Flatten the loop (1) (folded for shipping) and apply PVC adhesive (not provided) around the ends of the PVC and around the inside edge of the PVC coupling where they will fit together (2). Fit the pipe securely into the couplings. Lay the loop flat in the drive-thru lane, and position it as it is in the illustration on the back of this page. Elevate the loop on supports that are anchored to the ground, as shown on the side-view illustration on the back of this page. Level the loop so it will be 2 inches or less from the paved surface when the concrete is poured. Secure the loop to the • Determine if the enclosed 3 foot PVC loop extension reaches from the loop to the outlets of the conduit coming from the building to the speaker post. If it does, proceed to the next paragraph. If not, substitute a longer piece of 1/2 inch PVC (not included). Measure and cut it to reach from the • Pull the loop wires through the sleeve coupling (3) and the PVC loop extension (4). Apply PVC adhesive around the nipple on the corner fitting of the loop (5), around the inside edges of the sleeve coupling, and around the ends of the loop extension. Slide one end of the sleeve coupling over the nipple, and slide the glued end of the loop extension into the other end of the sleeve Pull the loop wires through the elbow coupling (7) and the remaining 2 foot piece of PVC (8). Put PVC adhesive around the end of the 2 foot PVC and the inside edges of the elbow coupling. Slide the two ends into the coupling, positioning the 2 foot piece of PVC so it points upward, out of the ground. Be certain the 2 foot PVC is next to and parallel to the outlets from the conduit coming

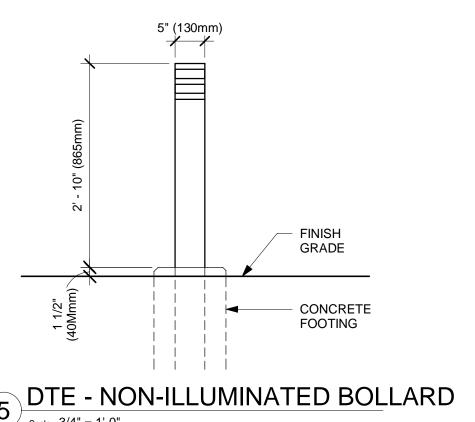

\ POST

PARTS LIST

PROCEDURE

HME sales representative.

1) PREFAB (FOLDED) LOOP, 1.5 FEET WIDE BY 5 FEET LONG

supports with wire, so the loop will not float when the concrete is poured.

loop to the point where it must exit the ground into the speaker post.

1. Check the contents of this package against the parts list. If any item is missing, contact your

2) COUPLING FOR 1/2 INCH PVC TUBING

4) 1/2 INCH PVC TUBING, 2 FEET LONG

5) 1/2 INCH PVC TUBING, 3 FEET LONG

provided) in place of the 3 foot loop extension.

3. Assemble the loop as follows:

3) 90 DEGREE ELBOW FOR 1/2 INCH PVC TUBING

ASPHALT OR VEHICLE CONDUIT CONCRETE **DETECTOR** FROM INSIDE LOOP BUILDING GRAVE & SAND LOOP SPEAKE SUPPORT

6 DTE - DETECTOR LOOP INSTALLATION - ISOMETRIC1

Scale: 1/2" = 1'-0"

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07363

03364-075

STORE #: PROJECT #:

ISSUE DATE: 02/14/2022 DESIGN MANAGER: NATALIA ROSENTHAL PRODUCTION DESIGNER: MB/EE CHECKED BY:

Revision Schedule			
Rev	Date	Ву	Description
	T TITL C		1


SITE DETAILS

SCALE: AS SHOWN SHEET NUMBER:

A003

SITE DETAIL DRAWINGS FOR REFERENCE ONLY. SIGN VENDOR TO ENGINEER AND PULL PERMIT FOR SIGNAGE FEATURES.

SIDE ELEVATION

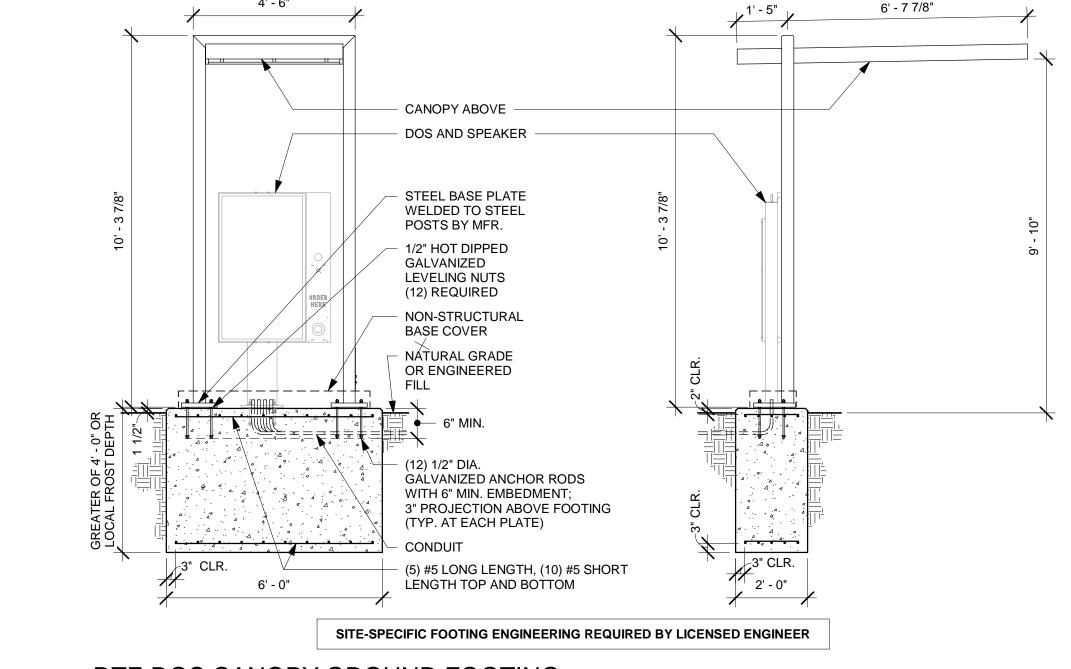

SEE GROUND FOOTING
DETAIL FOR ROD LENGTH

SEE SEPARATE DETAIL FOR ANCHOR ROD PATTERN IN FOUNDATION


ALTERNATE ADHESIVE POST-INSTALLED ANCHORS:
HILTI 5/8" DIA. HVU ADHESIVE CAPSULES AT 9" EMBEDMENT WITH A36
HOT-DIPPED GALVANIZED THREADED STEEL RODS AND HARDWARE.

(12) REQUIRED

1/2" HEAVY HEX
NUT WITH WASHER
ANCHOR RODS WITH GALVANIZED HARDWARE

SITE-SPECIFIC FOOTING ENGINEERING REQUIRED BY LICENSED ENGINEER

DTE DOS CANOPY ANCHOR ROD

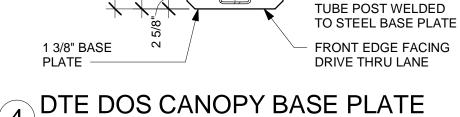

THRU HOLE FOR

ANCHOR BOLT

(TYP 1 OF 4)


MOUNTING (TYP.)


4" X 4" X 0.25" STEEL

DTE DOS CANOPY GROUND FOOTING

Scale: 3/8" = 1'-0"

FRONT ELEVATION

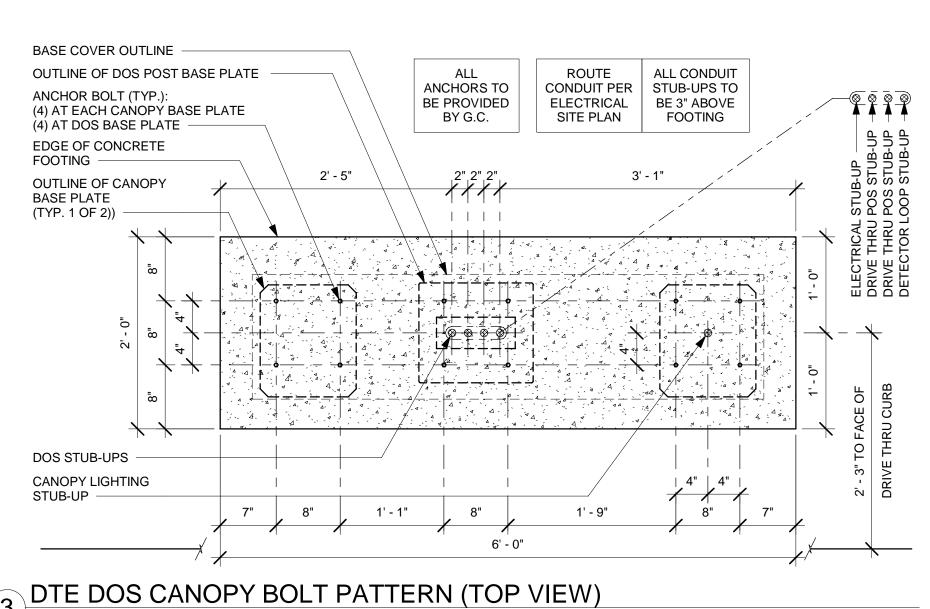

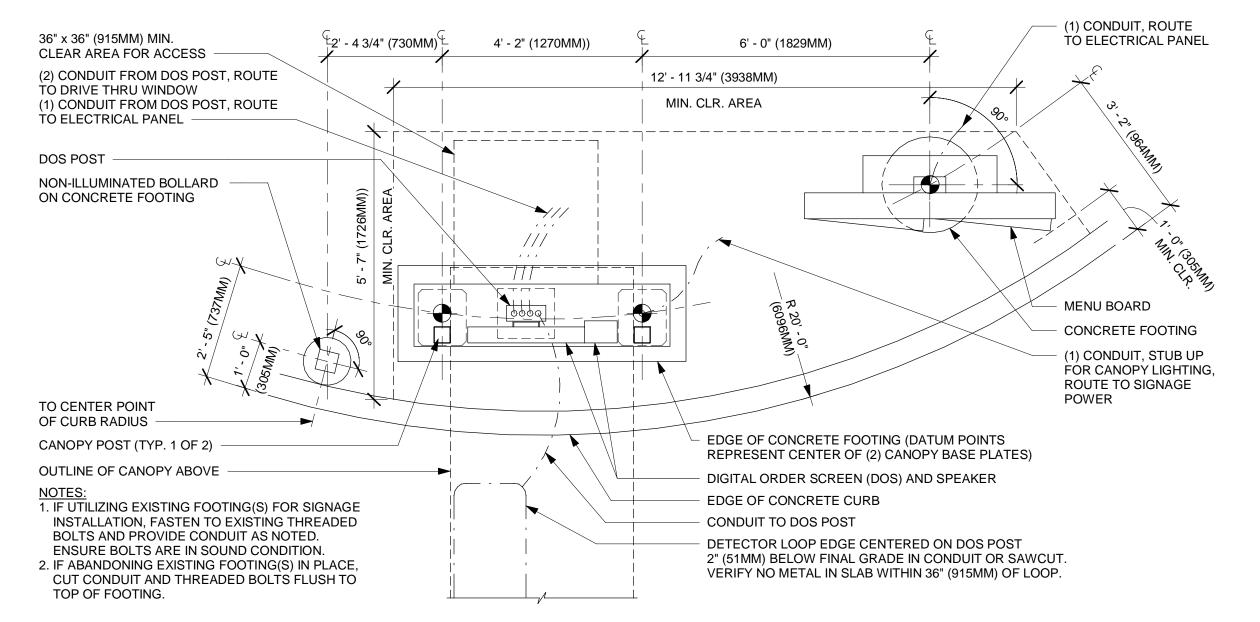

DTE - 3 PANEL 0° DT MENU BOARD, DIG. ORDER SCREEN W/ CANOPY - CURVE

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LICENSE NO: 029335
EXPIRATION DATE: 07/31/2023

ROJECT NAME:

PROJECT ADDRESS: 2303 NOTT STREET B

STORE #: PROJECT #:

07363 03364-075

ISSUE DATE: 02/14/2022
DESIGN MANAGER: NATALIA ROSENTHAL
PRODUCTION DESIGNER: MB/EE
CHECKED BY: HVT

Revision Schedule


Rev Date By Description

SHEET TITLE:
SITE DETAILS

SCALE: AS SHOWN
SHEET NUMBER:

A004

0/21/2022 10:20:02 AM

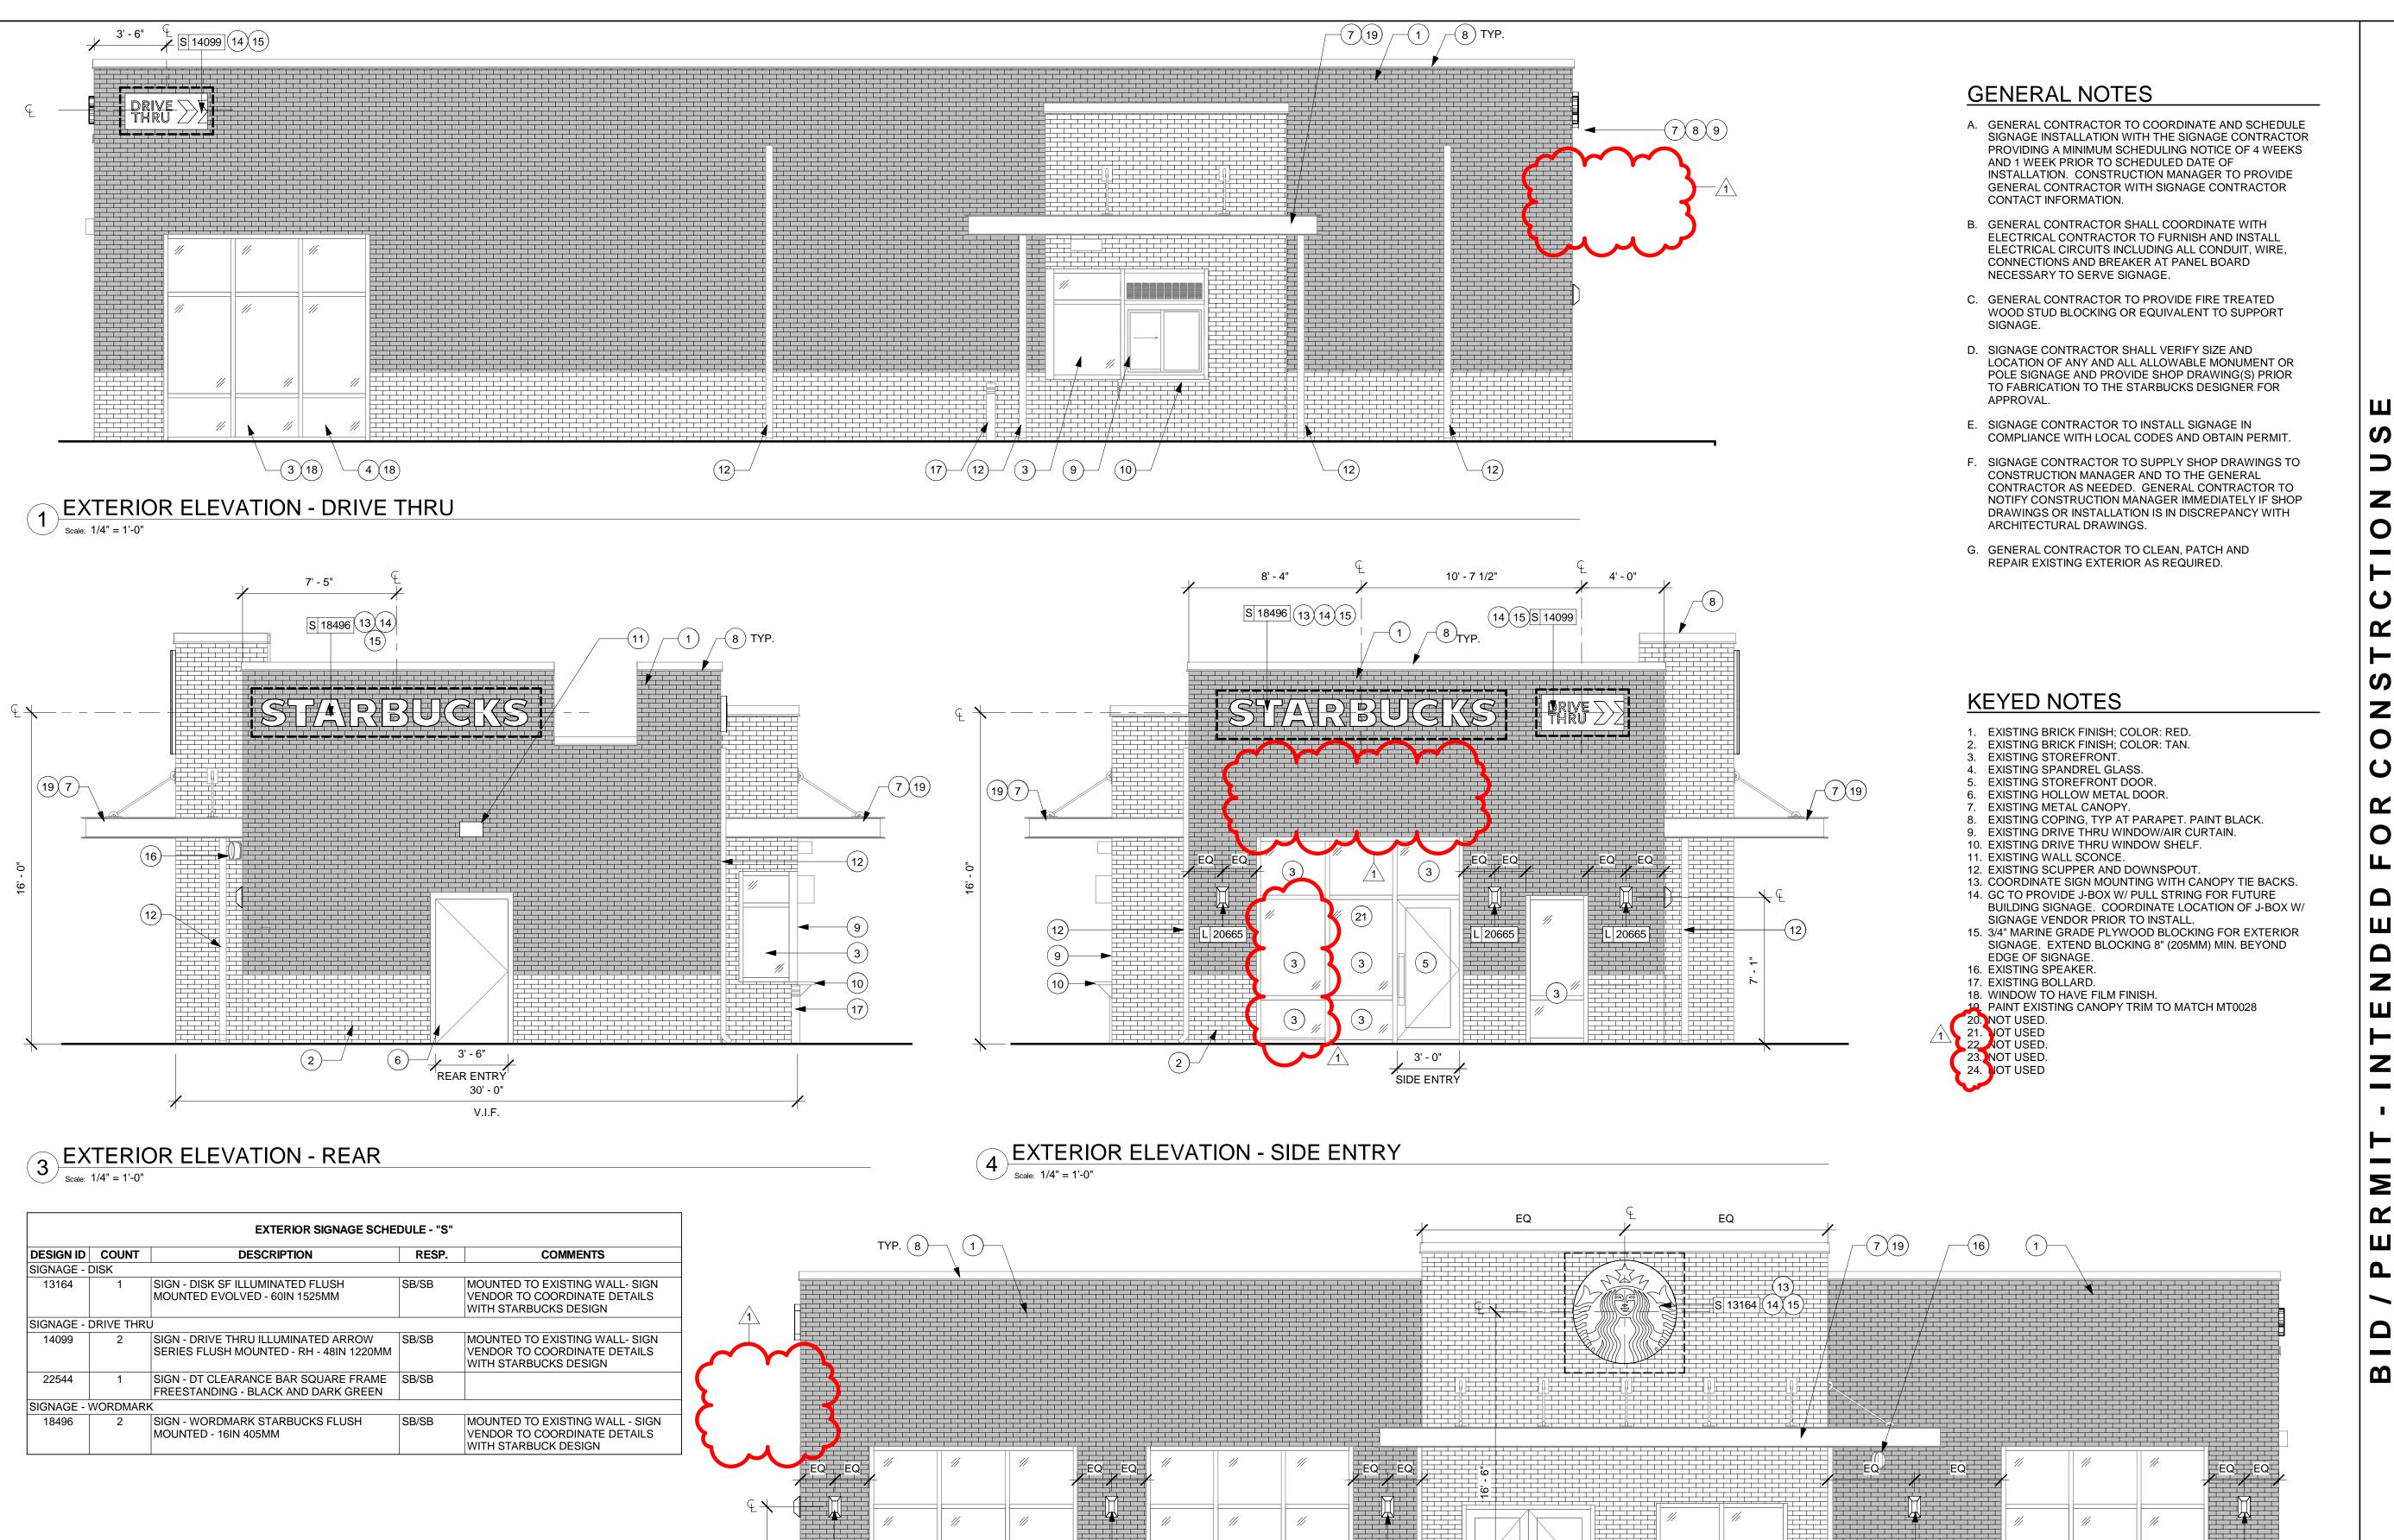

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20665

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EXPIRATION DATE: 07/31/2023

SKAYUNA
SKAYUNA

07363

STORE #: 07363
PROJECT #: 03364-075
ISSUE DATE: 02/14/2022

DESIGN MANAGER: NATALIA ROSENTHAL PRODUCTION DESIGNER: MB/EE CHECKED BY: HVT

Revision Schedule

 Rev
 Date
 By
 Description

 1
 04/12/22
 REVISIONS TO SITE SCOPE

BUILDING EXTERIOR ELEVATIONS

SHEET NUMBER:

SCALE: AS SHOWN

L 20665

A201

0000 40.04.4E AM

EXTERIOR ELEVATION - MAIN ENTRY

Scale: 1/4" = 1'-0"

L 20665

SITE SCHEDULE - "Y"					
DESIGN ID	COUNT	DESCRIPTION	RESP.	COMMENTS	
EXTERIOR N	ЛENU				
22541	1	MENU BOARD - DT 3 PANEL SQUARE FRAME FREESTANDING - 63X62IN 1600X1575MM - BLACK	SB/SB		
22546	2	MENU BOARD - DT DIGITAL ORDER SCREEN WITH POST - BLACK	SB/SB		
OTHER			•		
14103	1	BOLLARD NONILLUMINATED SQUARE - FLAT BLACK MT0028	SB/GC		
22543	1	DT ORDER POINT CANOPY SQUARE FRAME - BLACK	SB/SB		
X0011	1	DT WINDOW SHELF - 48IN 1205MM - SST	SB/GC	BY READY ACCESS	
X0011	1	VEHICLE LOOP DETECTION	SB/GC	BY HME; CONDUIT MUST BE INSTALLED PRIOR TO PAVING; GC TO COORDINATE WITH PAVING CONTRACTOR	
UMBRELLA					
10068	3	UMBRELLA - IN GROUND - 6FT 183CM - GREEN CANVAS WITH STARBUCKS WORDMARK F0056	SB/GC		
18714	3	UMBRELLA - BASE 200LB 90KG - FLAT BLACK MT0028	SB/GC		

DESIGN ID	COUNT	NT DESCRIPTION		COMMENTS
SIGNAGE - [DISK		•	
13164	1	SIGN - DISK SF ILLUMINATED FLUSH MOUNTED EVOLVED - 60IN 1525MM	SB/SB	MOUNTED TO EXISTING WALL- SIGN VENDOR TO COORDINATE DETAILS WITH STARBUCKS DESIGN
SIGNAGE - [DRIVE THRU	j		
		SIGN - DRIVE THRU ILLUMINATED ARROW SERIES FLUSH MOUNTED - RH - 48IN 1220MM	SB/SB	MOUNTED TO EXISTING WALL- SIGN VENDOR TO COORDINATE DETAILS WITH STARBUCKS DESIGN
22544	1	SIGN - DT CLEARANCE BAR SQUARE FRAME FREESTANDING - BLACK AND DARK GREEN	SB/SB	
SIGNAGE - V	VORDMARI	ζ		
18496	2	SIGN - WORDMARK STARBUCKS FLUSH MOUNTED - 16IN 405MM	SB/SB	MOUNTED TO EXISTING WALL - SIGN VENDOR TO COORDINATE DETAILS WITH STARBUCK DESIGN



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LICENSE NO: 029335
EXPIRATION DATE: 07/31/2023

PROJECT NAME:
NISKAYUNA

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PROJECT ADDRESS: 2303 NOTT STREET EAST NISKAYUNA, NY 12309

07363

STORE #: PROJECT #:

PROJECT #: 03364-075

ISSUE DATE: 02/14/2022
DESIGN MANAGER: NATALIA ROSENTHAL

PRODUCTION DESIGNER: MB/EE
CHECKED BY: HVT

Revision Schedule

Rev	Date	Ву	Description


SHEET TITLE:
SCHEDULES

SCALE: AS SHOWN

SHEET NUMBER:

A601

2/21/2022 10:20:20 AM

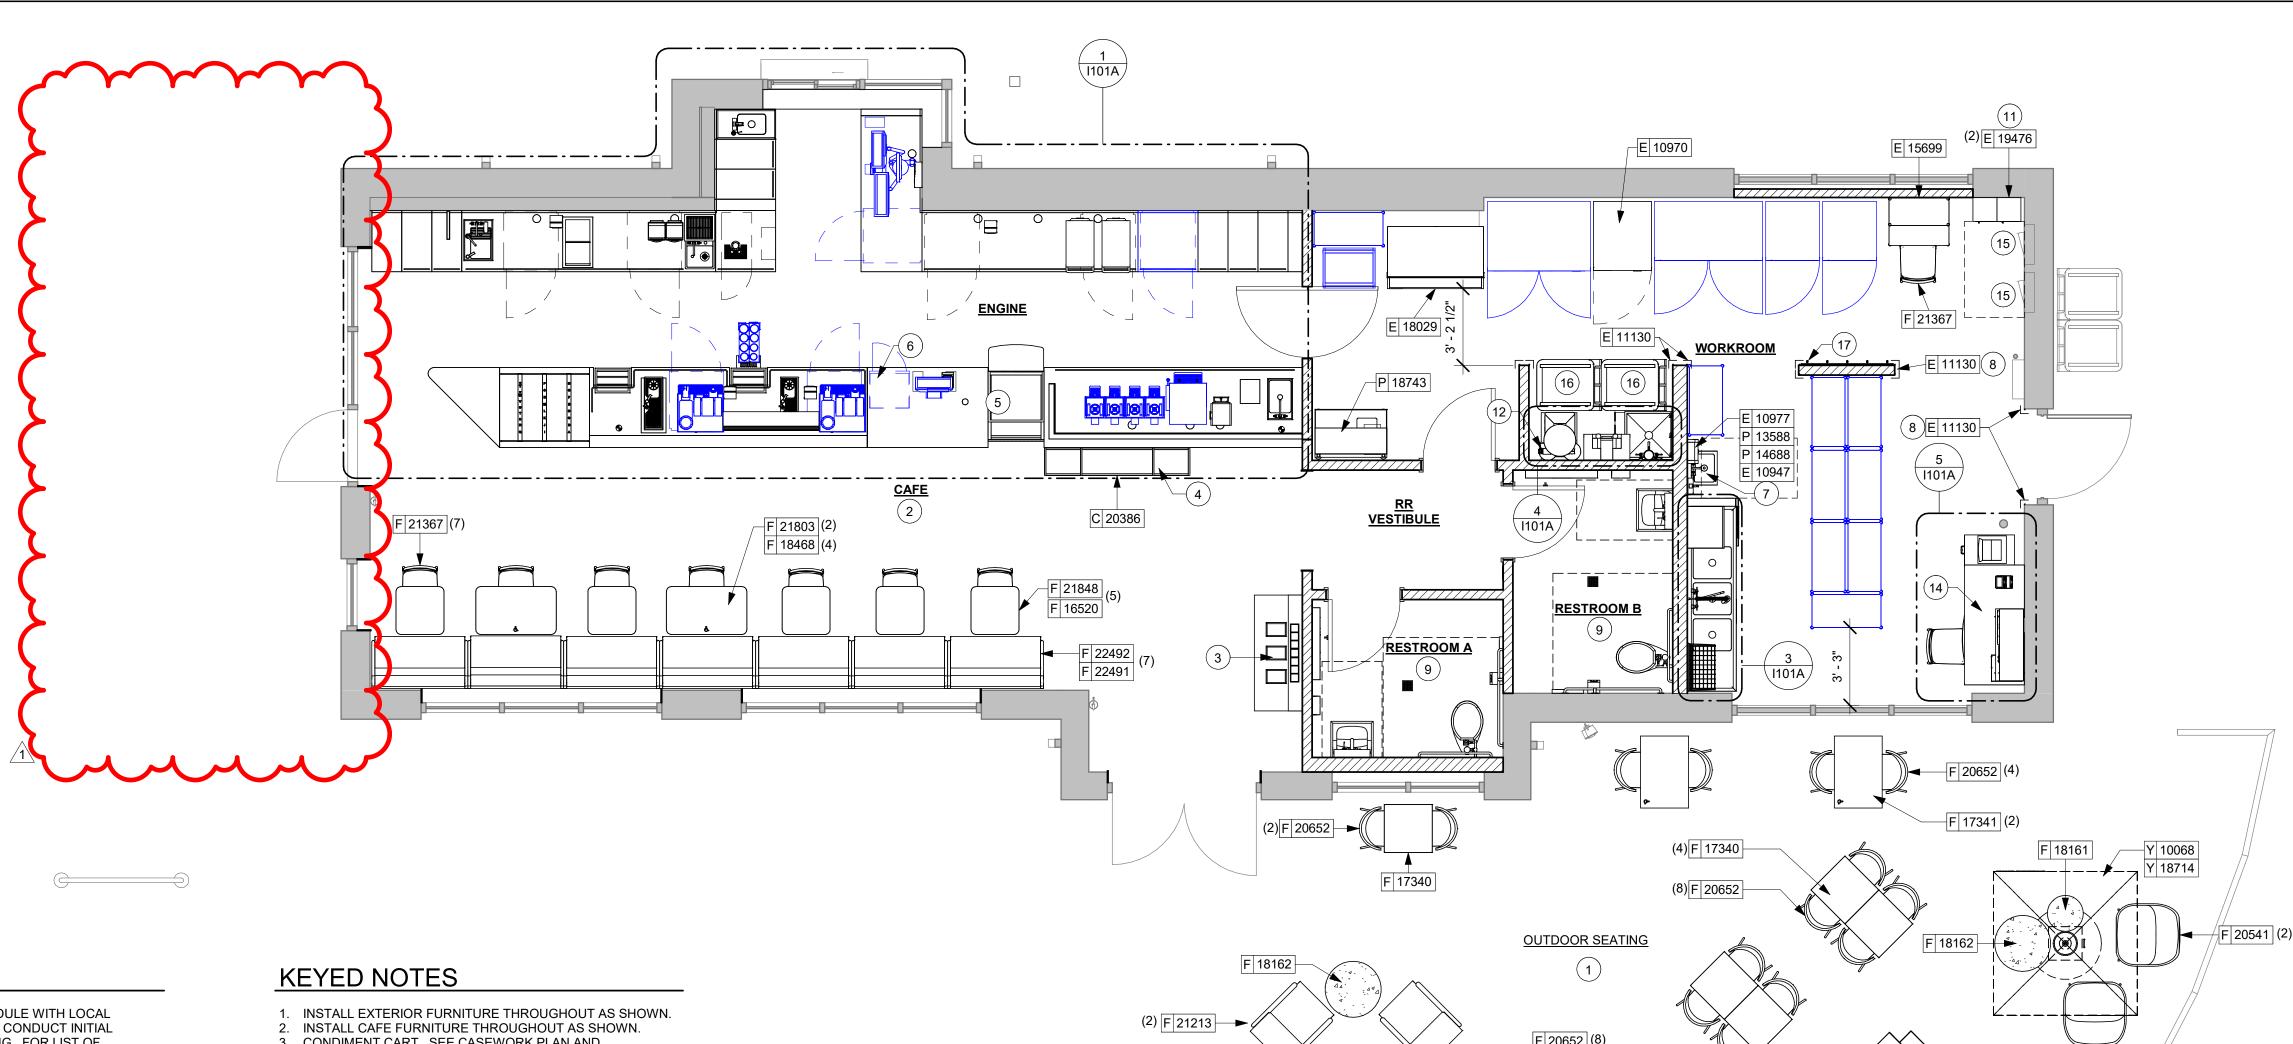

GENERAL NOTES

- A. GENERAL CONTRACTOR TO SCHEDULE WITH LOCAL REFRIGERATION CONTRACTOR TO CONDUCT INITIAL FOOD CASE START-UP AND TESTING. FOR LIST OF APPROVED START UP CONTRACTORS, CONTACT PROJECT CONSTRUCTION REPRESENTATIVE.
- B. THE SITE IS SERVED BY THE MUNICIPAL WATER AND SEWER SYSTEM UNLESS OTHERWISE NOTED.
- C. ALL FLOOR AND WALL JUNCTIONS IN STORAGE AND PREP. AREAS SHALL HAVE A 6" COVED BASE.
- D. ALL FOOD STORAGE SHALL BE 6" (150mm) A.F.F.
- E. ALL WOOD SURFACES (DOORS, TRIM, SHELVES,

CABINETS) SHALL BE SÈALED.

- F. FLOORS, WALLS AND CEILING FINISHES IN FOOD PREP.
 AREAS SHALL BE SMOOTH, NON-TOXIC, NON-
- ABSORBENT, DURABLE AND EASILY CLEANABLE. PAINT SHALL BE WASHABLE AND SEMI-GLOSS OR HIGH-GLOSS FINISH.
- G. ALL EQUIPMENT AND INSTALLATION WILL MEET NATIONAL SANITATION FOUNDATION STANDARDS OR EQUIVALENT.
- H. ALL EQUIPMENT AND CABINETRY WILL BE FLUSH MOUNTED TO COUNTERS, WALLS OR FLOORS, OR BE RAISED TO ALLOW FOR CLEANING.
- I. CONFIRM ALL NECESSARY CLEARANCES PER PRODUCT CUT SHEET REQUIREMENTS FOR ALL EQUIPMENT (E.G. ICE MACHINE).
- J. FOR LOCATION OF COUNTERTOP EQUIPMENT, REFER TO CASEWORK ELECTRICAL DETAILS.
- K. EQUIPMENT UNITS SHALL CONTAIN NO EXPOSED THREADS, EMBELLISHMENTS OR OVERHANGING EDGES THAT SERVE AS PLACES FOR ACCUMULATION OF DUST, DIRT AND DEBRIS.
- L. WARMING OVEN(S) SHOWN FOR PERMITTING PURPOSES. INSTALLATION AT STORE OPENING TO BE VERIFIED BY STARBUCKS CONSTRUCTION REPRESENTATIVE.
- M. EACH HAND WASHING SINK WILL HAVE A SINGLE SERVICE TOWEL AND SOAP DISPENSER, AND ALL HAND SINKS TO HAVE A COMBINATION FAUCET OR PREMIXING FAUCET.
- N. FOR PLUMBING FIXTURES, REFER TO THE PLUMBING DESIGN PLAN. FOR DATA DEVICE SCHEDULE, REFER TO THE ELECTRICAL DESIGN PLAN.
- O. SEE ELEVATIONS FOR DISTRIBUTION OF CUP DISPENSERS.
- P. GENERAL CONTRACTOR TO COORDINATE
 NEWSPAPER FIXTURE ORDERING. CONTACT TRIAD
 MANUFACTURING BY EMAIL (starbuckscs@triadmfg.com) OR
 BY PHONE (314-381-5280 X1111) TO ARRANGE SHIPMENT
 OF THE FIXTURE. ALLOW (5) DAY LEAD-TIME.

- 3. CONDIMENT CART. SEE CASEWORK PLAN AND SCHEDULES.
- 4. MERCHANDISE DISPLAY. SEE DETAILS X/I50X FOR MORE INFORMATION.
- 5. DO NOT BLOCK FOOD CASE INTAKE/EXHAUST.
- 6. SAFE LOCATED AT POS CABINET. SEE ELECTRICAL FOR ADDITIONAL INFORMATION.
- 7. HAND SINK W/ INTEGRAL SPLASH GUARD.
- 8. INSTALL CORNER GUARD AS INDICATED. SEE INTERIOR FINISH ELEVATIONS.
 9. REFER TO ENLARGED RESTROOM PLANS AND ELEVATIONS (SHEET I401) FOR FIXTURE LOCATIONS AND MOUNTING
- HEIGHTS.

 10. LOCATION OF SWITCH GEAR AND THERMOSTAT CONTROLS.
- 11. SECURE LOCKERS TO WALL.12. VENDOR TO INSTALL WATER FILTRATION SYSTEM PER MANUFACTURER'S REQUIREMENTS. G.C. TO PROVIDE
- PLUMBING AND ELECTRICAL REQUIREMENTS.

 13. WATER HEATER LOCATED ABOVE. SEE PLUMBING
- 14. MANAGERS DESK. SEE MANAGER'S DESK/EQUIPMENT RACK ELECTRICAL DETAIL FOR ADDITIONAL INFORMATION.
- 15. ELECTRICAL PANELS. SEE ELECTRICAL PLANS. MAINTAIN 3'
- CLEARANCE AT FRONT. 16. TRASH BIN.
- 17. COAT RACK MOUNTED AT 48" AFF.
- 18. PLACE FIRE EXTINGUISHER IN WORKROOM PER FIRE

FURNITURE, FIXTURES, AND EQUIPMENT PLAN

Scale: 1/4" = 1'-0"



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EXPIRATION DATE: 07/31/2023

ROJECT NAME: VISKAYUNA

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SHOPRITE SQ PROJECT ADDRESS:

STORE #: 07363 PROJECT #: 03364-075

ISSUE DATE: 02/14/2022
DESIGN MANAGER: NATALIA ROSENTHAL
PRODUCTION DESIGNER: MB/EE
CHECKED BY: HVT

Revision Schedule			
Rev	Date	Ву	Description
1	04/12/22		REVISIONS TO SITE SCOPE

SHEET TITLE:
FF & E PLAN

SCALE: AS SHOWN

SHEET NUMBER:

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F 19327 (2)

F 18162

⊢Y 10068

F 17340 (4)

F 18161


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22-59788



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QID 22-59788

JOB NAME

Starbucks 7363

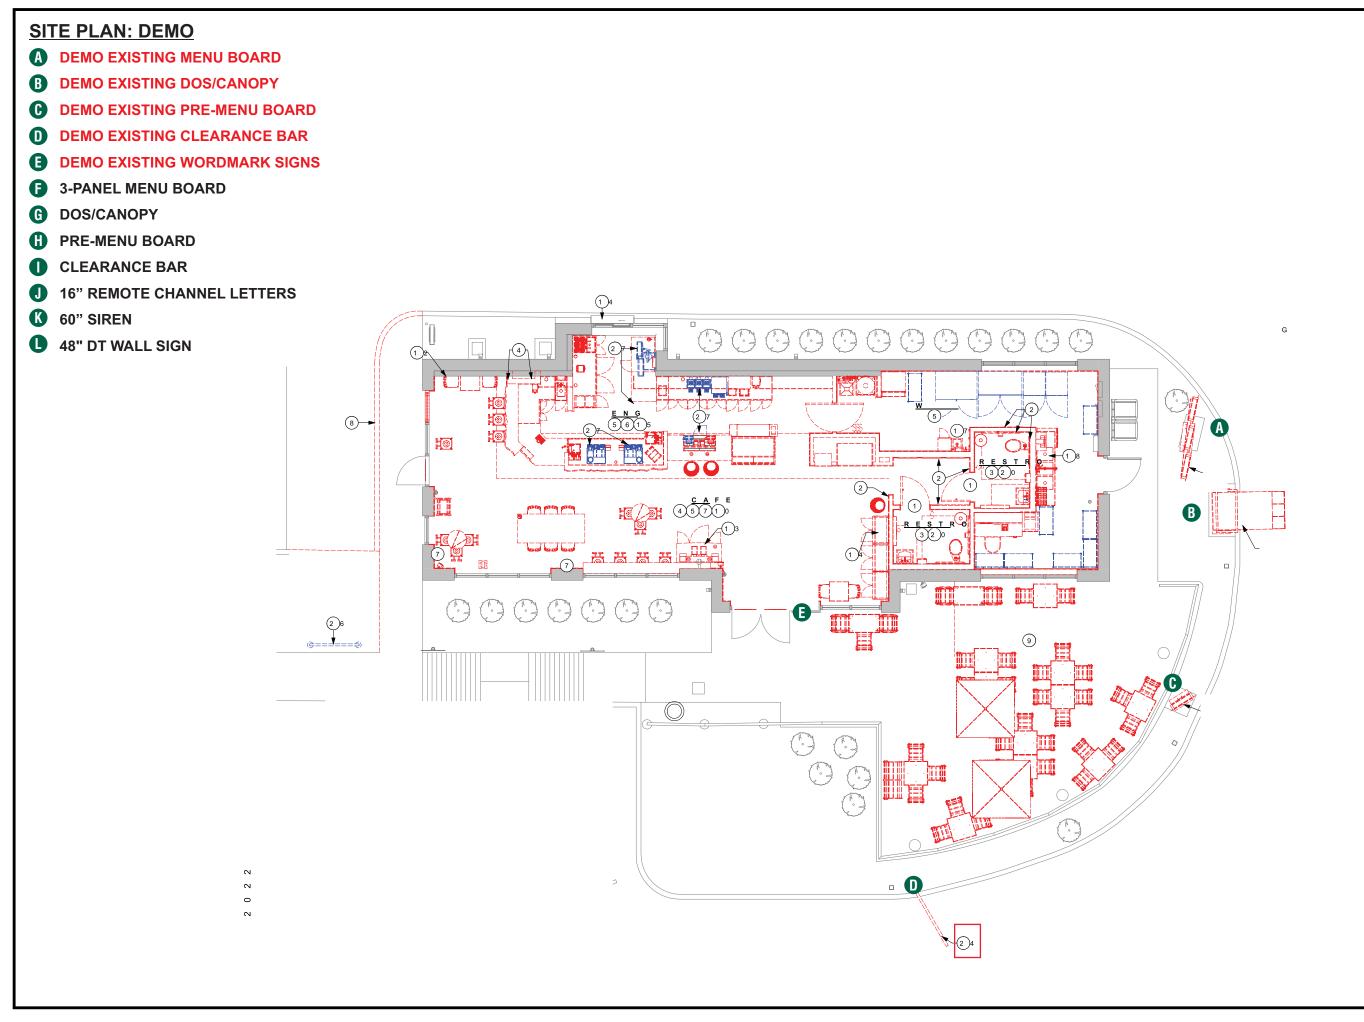LOCATION

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CUSTOMER CONTACT

SALESMAN / PM

Morgan Aussprung

DESIGNER

Brian Sowder

DWG. DATE

3-1-22

REV. DATE / REVISION

4-21-22

SCALE

As Noted

FILE

2022/Starbucks/Locations/ Niskayuna NY/22-59788/ SB Niskayuna NY 22-59788

DESIGN SPECIFICATIONS ACCEPTED BY:

EST:	CLIENT:
SLS/PM:	LANDLORD:

THE INTENT OF THIS DRAWING IS TO SHOW A CONCEPTUAL REPRESENTATION OF THE PROPOSED SIGNAGE. DUE TO VARIATIONS IN PRINTING DEVICES AND SUBSTRATES, THE FINISHED PRODUCT MAY DIFFER SLIGHTLY FROM DRAWING.





SITE PLAN: PROPOSED

A DEMO EXISTING MENU BOARD

B DEMO EXISTING DOS/CANOPY

() DEMO EXISTING PRE-MENU BOARD

D DEMO EXISTING CLEARANCE BAR

E DEMO EXISTING WORDMARK SIGNS

3-PANEL MENU BOARD

G DOS/CANOPY


(II) PRE-MENU BOARD

CLEARANCE BAR

16" REMOTE CHANNEL LETTERS

60" SIREN

48" DT WALL SIGN

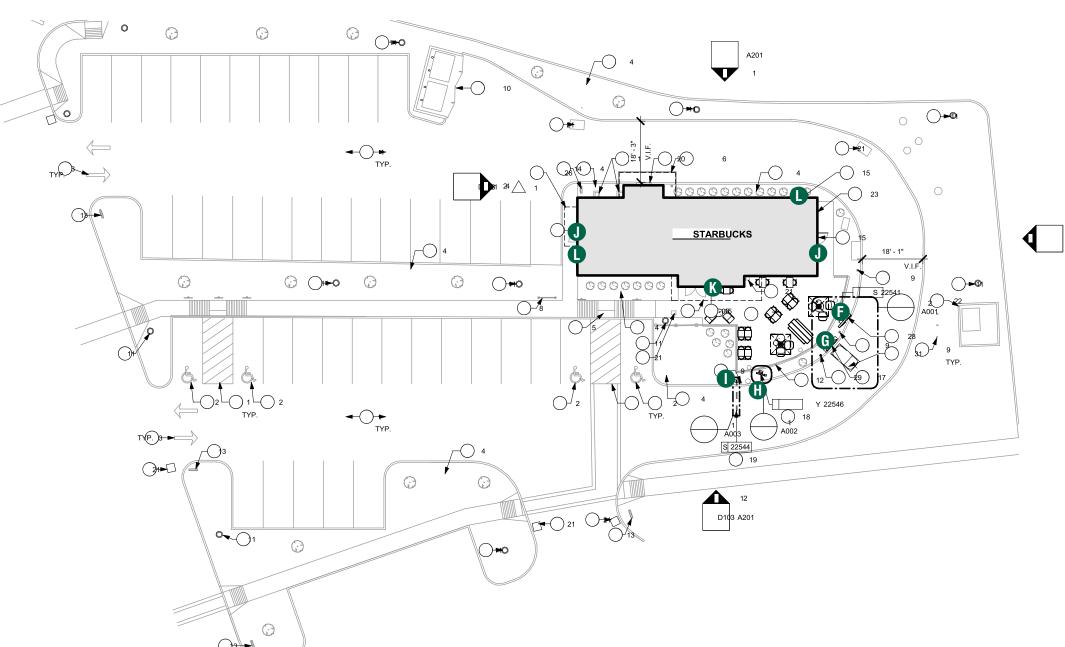

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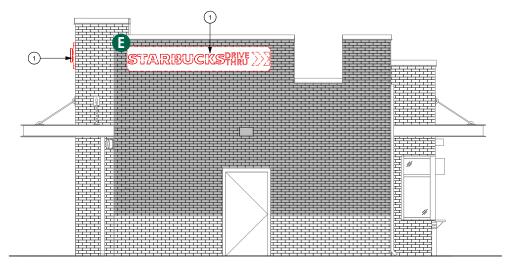
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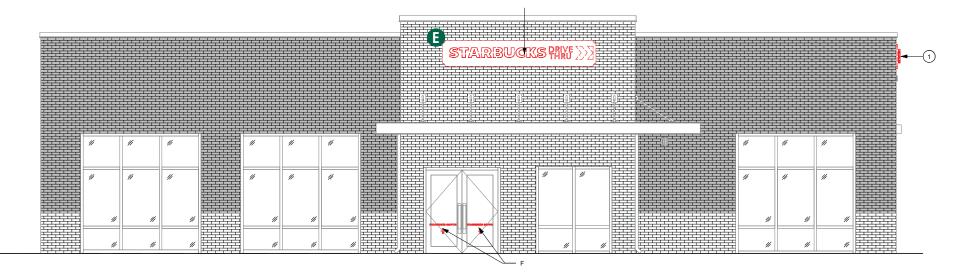
ELEVATION: EXISTING

- **A** DEMO EXISTING MENU BOARD
- **B** DEMO EXISTING DOS/CANOPY
- **©** DEMO EXISTING PRE-MENU BOARD
- **D** DEMO EXISTING CLEARANCE BAR
- **E** DEMO EXISTING WORDMARK SIGNS
- **3-PANEL MENU BOARD**
- **(f)** DOS/CANOPY
- **(H)** PRE-MENU BOARD
- CLEARANCE BAR
- **16" REMOTE CHANNEL LETTERS**
- 60" SIREN
- 48" DT WALL SIGN



Rear Elevation

Scale: 1/18" = 1' (11x17 paper)



Front Elevation

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SCALE

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FILE

2022/Starbucks/Locations/ Niskayuna NY/22-59788/ SB Niskayuna NY 22-59788

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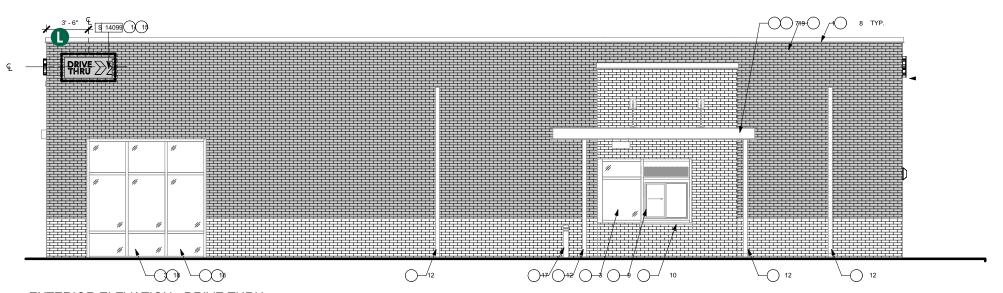
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- H PRE-MENU BOARD
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EXTERIOR ELEVATION - DRIVE THRU

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SCALE

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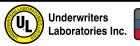
FILE

2022/Starbucks/Locations/ Niskayuna NY/22-59788/ SB Niskayuna NY 22-59788


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- **A** DEMO EXISTING MENU BOARD
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FILE


2022/Starbucks/Locations/ Niskayuna NY/22-59788/ SB Niskayuna NY 22-59788

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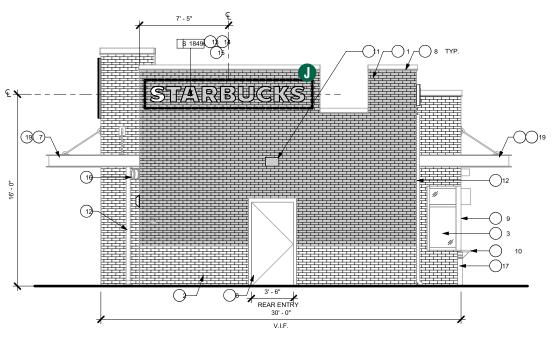
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- **A** DEMO EXISTING MENU BOARD
- **B** DEMO EXISTING DOS/CANOPY
- **C** DEMO EXISTING PRE-MENU BOARD
- **D** DEMO EXISTING CLEARANCE BAR
- **E** DEMO EXISTING WORDMARK SIGNS
- **3-PANEL MENU BOARD**
- **G** DOS/CANOPY
- H PRE-MENU BOARD
- CLEARANCE BAR
- **1** 16" REMOTE CHANNEL LETTERS
- 60" SIREN
- 48" DT WALL SIGN



EXTERIOR ELEVATION - REAR

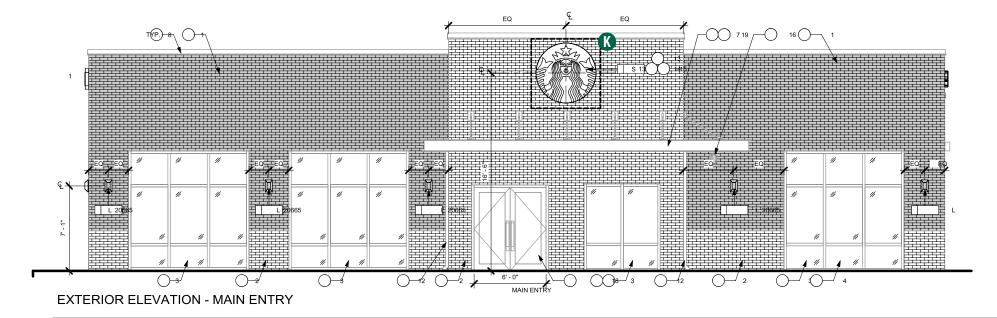Scale: 1/18" = 1' (11x17 paper)

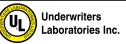HILTONDISPLAYS

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QID 22-59788

JOB NAME

Starbucks 7363

LOCATION

2303 Nott Street East Niskayuna NY 12309

CUSTOMER CONTACT

SALESMAN / PM

Morgan Aussprung

DESIGNER

Brian Sowder

DWG. DATE

3-1-22

REV. DATE / REVISION

4-21-22

SCALE

As Noted


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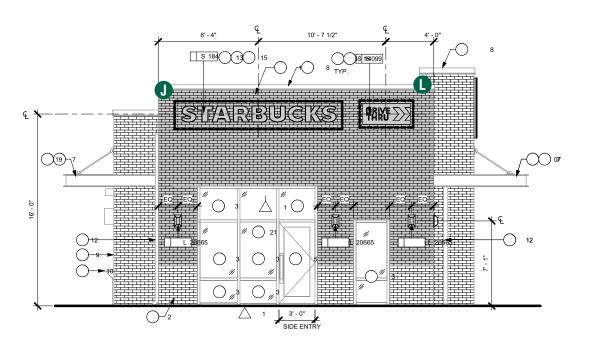
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- G DOS/CANOPY
- H PRE-MENU BOARD
- CLEARANCE BAR
- **16" REMOTE CHANNEL LETTERS**
- 60" SIREN
- 48" DT WALL SIGN



EXTERIOR ELEVATION - SIDE ENTRY

Scale: 1/18" = 1' (11x17 paper)

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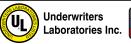
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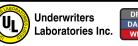
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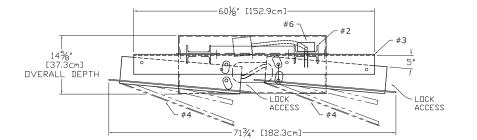


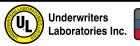


3-PANEL MENU - FREESTANDING

Qty. 1

(3)



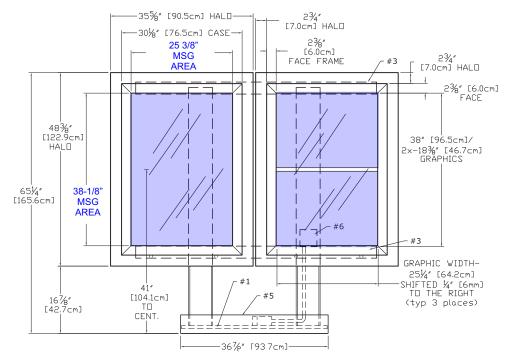



MESSAGE AREA: 38 1/8" X 25 3/8")/ 144X 2=13.56 SF


DTE - MENU 3 PANEL FREESTANDING

Scale: 1/2" = 1' (11x17 paper)



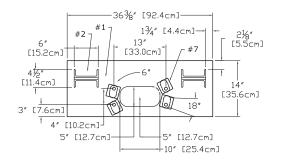

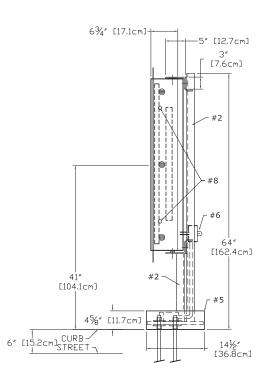

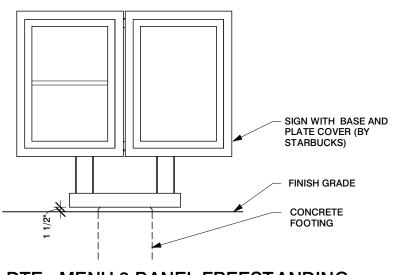

DTE - MENU 3 PANEL FREESTANDING

Scale: 3/8" = 1' (11x17 paper)

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SCALE

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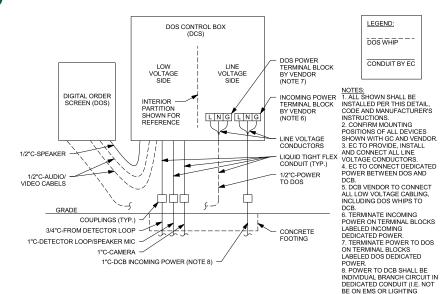




DOS ON CANOPY - DCB ON UNISTRUT

Qty. 1





CANOPY BASE SHROUD 3/4" DIA. STUB-UP 1 1/2" SQ. UNISTRUT FRAME; ANCHOR TO FTG. CONCRETE FOOTING FOR DOS CONTROL BOX DOS CONTROL BOX ABOVE

DTE - DOS CONTROL BOX CONDUIT STUB-UPS AT CANOPY

CONTROL BOX FASTENED TO FRAME 1 1/2" SQ. UNISTRUT FRAME; ANCHOR TO FTG CANOPY MESH CONDUIT WITH WATERTIGHT COUPLING PER ELECTRICAL ROUTE DOS POWER WHIP THROUGH MESH OPENING — CANOPY BASE SHROUD CONDUIT PER ELECTRICAL CONCRETE FOOTING SECTION

DTE - DOS CONTROL BOX AT CANOPY

Scale: 1/2" = 1' (11x17 paper)

DTE - DOS CONTROL BOX WIRING

Scale: 1/2" = 1' (11x17 paper)

Scale: 1/2" = 1' (11x17 paper)


- #1 TWO 3 ₄" [19mm] STEEL BASE PLATES w/ OVAL HOLES FOR SWIVEL/POSITION
- 16 1₄" WASHERS SUPPLIED #2 TWO BACK TO BACK C4X7.25
- (4"x1³₄"x⁵₁₆") STEEL POSTS #3 WELDED ALUMINUM HEADER,


LEGEND:


DOS WHIP

CONDUIT BY EC


- C4"X1.58" CHANNEL
- #4 THREE ALUMINUM ROOF PANELS SEAMLESS RAISED SIDE EDGES 15" OF LASERED PATTERN W/ DRIP EDGE BEHIND
- #5 WELDED STEEL PERIMETER ROOF FRAME
- #6 WELDED 3₁₆" STEEL [5mm] MONITOR SUPPORT FRAME WITH HGT ADJUSTMENT #7 - WELDED STEEL 1" [25.4mm] O-C WIRE
- GRID BACK & SIDE PANELS IN WELDED RECTANGULAR STEEL TUBE FRAMES
- 4⁷₁₆" X ¹₂" [11.3cmX12.7mm] WHITE ACRYLIC LETTERS. FIXED TO LH GRID PANEL W/ANTI-TAMPER SCREWS #9 - WELDED ALUMINUM BASE COVERS
- #10 WELDED ALUMINUM WATER-TIGHT ELECTRIC ENCLOSURE (REAR HATCH)
- #11 LED CEILING FLOODLIGHT, WIRED COMPLETE

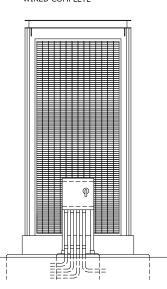


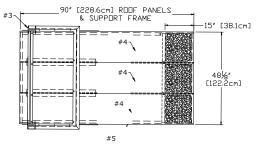

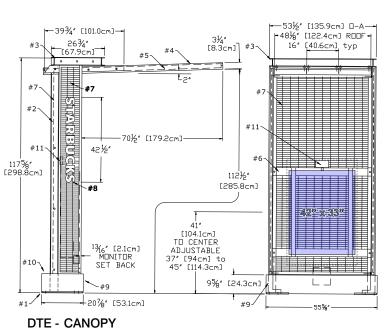

Scale: 1/4" = 1' (11x17 paper)

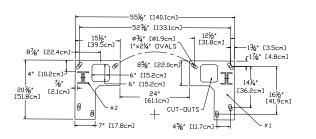

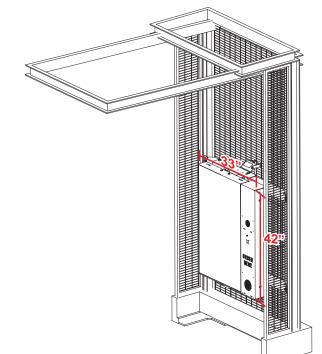

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SALESMAN / PM

Morgan Aussprung

DESIGNER

Brian Sowder

DWG. DATE

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REV. DATE / REVISION

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SCALE

As Noted

FILE

2022/Starbucks/Locations/ Niskayuna NY/22-59788/ SB Niskayuna NY 22-59788


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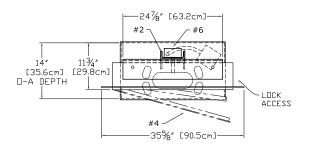





PRE-MENU BOARD - FREESTANDING

Qty. 1



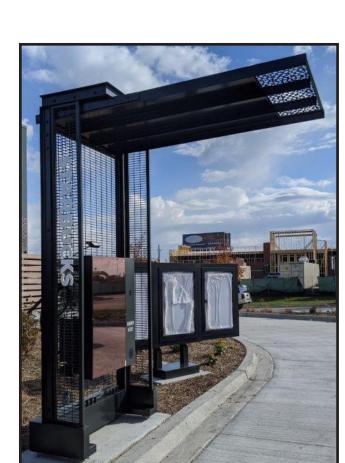

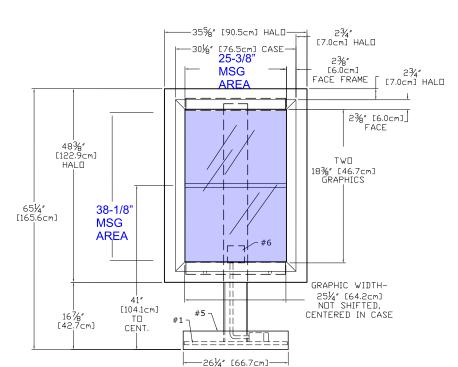



MESSAGE AREA = (25.375 * 38.125) / 144 = 6.72 SQ FT

DTE - PRE-MENU FREESTANDING


Scale: 1/2" = 1' (11x17 paper)



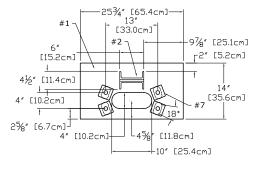

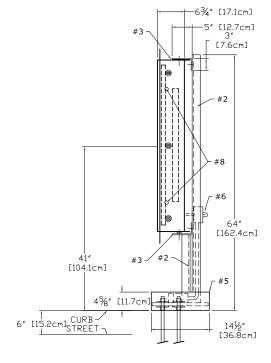

- #1 $\ensuremath{^{-3}\!\!\!\!/_{\!\!4}}$ [19mm] STEEL BASE PLATE w/ 18deg HOLES PATTERN LEFT SQUARE / SYMETRICAL
- #2 C6X10.5 (6"x2" x_{16}^{5} ") STEEL POST (1x)
- #3 5"x3"X1/4" STEEL SUPPORT ANGLES (2x) (WELDED TO STEEL POST)
- #4 EXTRUDED ALUMINUM MENU BOARD (1x) ONE SPLIT PANEL LIGHTBOX TWO 251/4"x183/8" GRAPHICS GRAPHIC ASSEMBLY CENTERED, NOT SHIFTED STANDARD LED TUBE LIGHTING, SIDE LOCKS
- #5 WELDED ALUMINUM BASE COVER
- #6 WATER-TIGHT BOX w/SWITCHES & SENSOR, RIDGID CONDUIT RUN TO SECOND EXT BOX BELOW BASE COVER, 120 WATT, 0.30Aac
- #7 8 BASE WASHERS, ½" THICK #8 TWO SIDE MOUNT LOCKS, RETAIN EXISTING KEY #E3-26-819-15

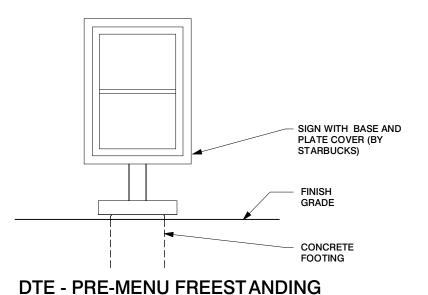

Scale: 3/8" = 1' (11x17 paper)

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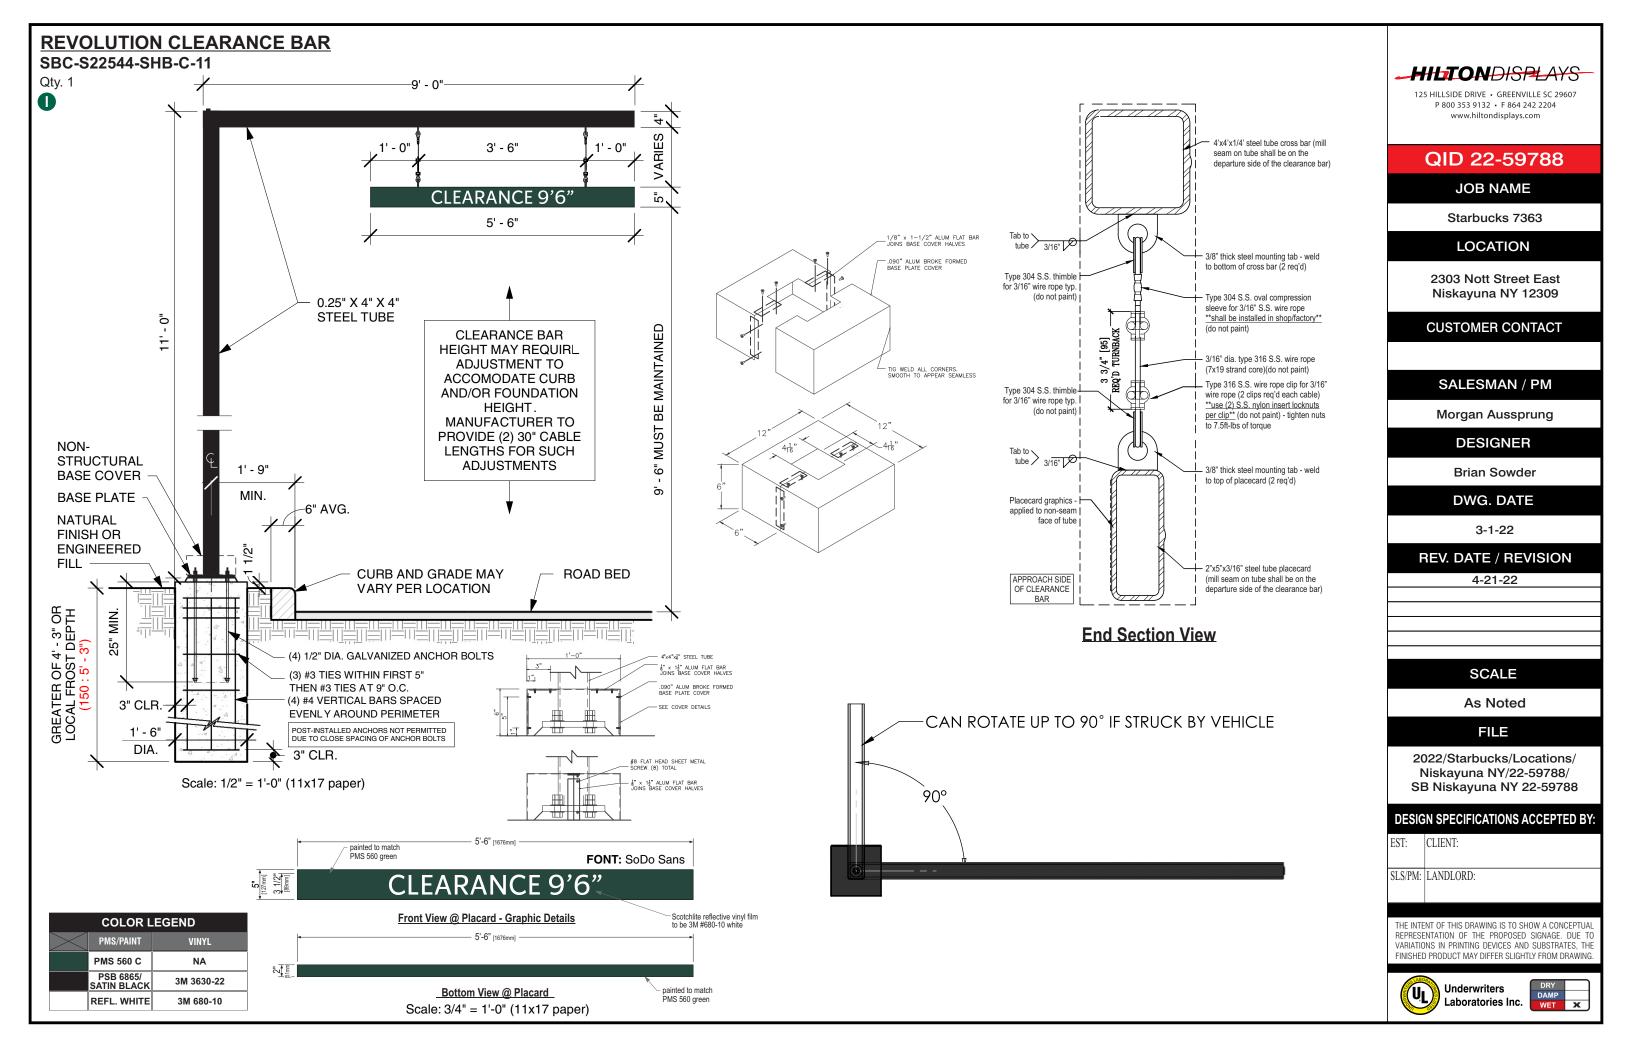
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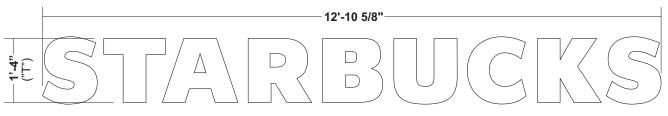


16" CHANNEL LETTERS - REMOTE

SBC-S18496-SB-W-SL

Qty. 2








Scale: 1/2" = 1' (11x17 Paper)

17.18 SF

SPECIFICATIONS

- A Internally illuminated channel letters to be fabricated from .040 returns aluminum with pre-painted White interiors and pre-finished Black returns. Letter backs to be aluminum stapled to sidewalls and sealed.
- **B** Faces to be 3/16" White acrylic with 1" Black trimcap Faces to be first surface 3M Scotchcal #3630-76 Holly Green vinyl with white acrylic portions to show through white.
- C Letters illuminated w/ Sloan Prism Enlighten White 6500k LED's w/ remote power supply.
- D Letters to be installed flush to wall.

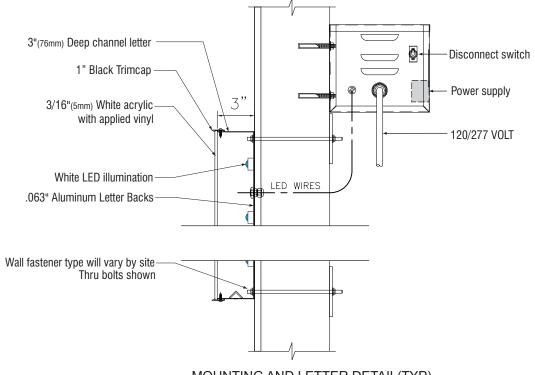

COLOR LEGEND VINYL PMS 3425 C 3M 3630-76 **RAL 7021M** 3M 3630-22 3M 3630-20/ 7725-10 PMS WHITE PMS 369 C NA REFL. WHITE 3M 680-10

MOUNTING AND LETTER DETAIL(TYP) SCALE: NTS

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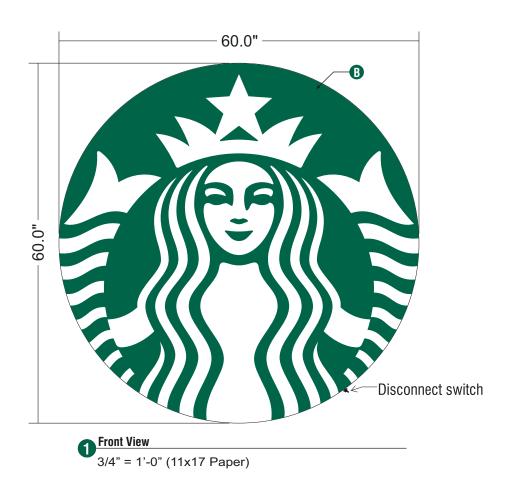


60" ILLUMINATED SIREN


Qty. 1

SBC-S13164-SL








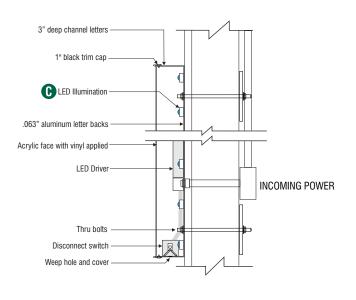

Disk Section View Typ.

SPECIFICATIONS:

- A Single faced internally illuminated wall mount logo disk. Cabinet to be 3" deep, fabricated aluminum returns and back. Paint cabinet black. Faces to be 3/16" white Plex with 1" black trimcap
- **B** Graphics of logo to be 1st surface 3M Translucent Scotchcal vinyl- Holly Green #3630-76. Siren to show thru White.
- (b) Internally illuminated logo disk with Sloan Prism Enlighten 6500K white LEDs

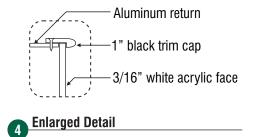

COLOR LEGEND				
\geq	PMS/PAINT	VINYL		
	PMS 3425 C	3M 3630-76		
	RAL 7021M	3M 3630-22		
	PMS WHITE	3M 3630-20/ 7725-10 TRANSLUCENT OPAQUE		
	PMS 369 C	NA		
	REFL. WHITE	3M 680-10		

Wall Mount EVOLVED				
Size	Sq.Ft.	Sq.M.	Volts	
60 " (1524mm)	19.62	1.82	120/277	

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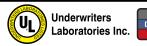
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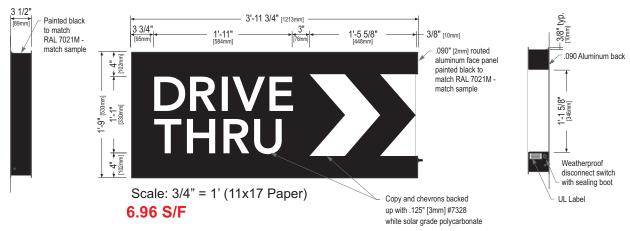
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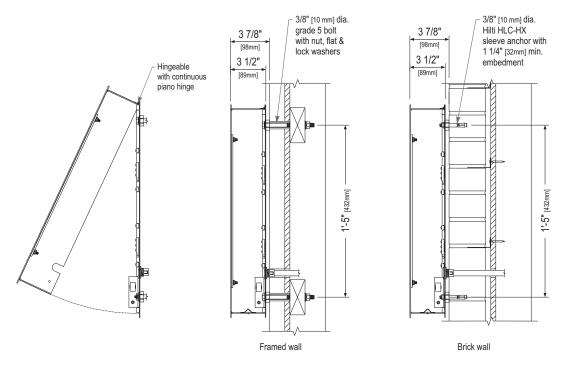
48" DT WALL SIGN-RH

Qty. 1 SBC-S14099-SL





Left Side View **Front Elevation View Right Side View**



Service Position View NOT TO SCALE

Section View at Installation Detail NOT TO SCALE

COLOR LEGEND				
><	PMS/PAINT	VINYL		
	PMS 3425 C	3M 3630-76		
	RAL 7021M	3M 3630-22		
	PMS WHITE	3M 3630-20/ 7725-10 TRANSLUCENT OPAQUE		
	PMS 369 C	NA		
	REFL. WHITE	3M 680-10		

Sign Specifications:

Cabinet:

- Fabricated .090" [2mm] aluminum housing painted black to match RAL 7021M with 3M #180-10 white vinyl end cap as shown.
- Directional copy and chevrons backed up with .125" white polycarb. All polycarb face elements to be attached to aluminum face panel with weld studs.
- Welded aluminum construction with no visible fasteners. Fasteners retaining the hinged face will be located on the bottom such that they are not visible. All fasteners used in the assembly of internal components shall be coated to prevent corrosion.
- Internal structure of cabinet shall be per approved shop drawings.
- Graphic elements are internally illuminated using Sloan Prism Enlighten LEDs. LED's to be mounted on back panel with self-contained power supply. All electrical components are removable for service.

- Sign must meet all regulations in the National Electric Code as well as any local or state electrical codes.
- As per NEC 600.6, sign is equipped with a service disconnect switch.
- Sign must be listed as an Electric Sign per Underwriters Laboratories UL48 and/or CSA and bear the appropriate UL, CUL or CSA relevant certification marks. Primary power by electrical contractor per NEC.

Size	Sq. Ft.1	Sq. Ft. ²	Volts	Amps
21"	4.52	6.96	120/277	0.85

^{1:} Figured as illuminated center part

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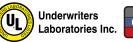
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^{2:} Figured as complete signage



TOWN OF NISKAYUNA

PLANNING BOARD AND ZONING COMMISSION

AGENDA STATEMENT

AGENDA ITEM NO. VIII. 3	MEETING DATE: 5/9/2022
ITEM TITLE: DISCUSSION: 1 Glen Eddy Dr. – site plan app. f Room addition.	or a main entrance and Dining
PROJECT LEAD: TBD	
APPLICANT: Mike Tierney	
SUBMITTED BY: Laura Robertson, Town Planner	
REVIEWED BY: ☐ Conservation Advisory Council (CAC) ☐ Zoning Board of Application Care and C	ppeals (ZBA) $\ \square$ Town Board
ATTACHMENTS: ☐ Resolution ■ Site Plan ☐ Map ☐ Report ☐ Other:	

SUMMARY STATEMENT:

Michael Tierney, of SPHP, submitted an Application for Site Plan Review for proposed internal and external modifications to the existing dining room and front entry porch of the Glen Eddy located at 1 Glen Eddy Drive. The existing covered front entry porch will be enclosed to increase the library, vestibule and office. The existing fabric roof will be replaced with copper roof that matches the existing building. The proposed modifications will protect residents from inclement weather during pick up and drop off at the main entrance.

The property falls within the R-1 Low Density Residential zoning district. Care homes and nursing homes are special principal uses in the R-1 district.

BACKGROUND INFORMATION

A 10-page "Site Plan Review Set" dated 5/3/22 with no subsequent revisions by Angerane Architects, P.C. was provided and includes the following drawings.

- Cover page
- Existing site plan C101
- Site grading plan C102
- Site utility plan –C103
- Site layout plan C104
- Site planting plan C105
- Site details C106
- Site details C107

- Site details C108
- Erosion control details and notes C109

A colored rendering entitled "The Terrace at Glen Eddy – Porte Cochere & Dining Room Additions" Scheme 4 dated 3/10/22 also by Angerame Architects, P.C. was also provided depicting how the front of the building will look after the proposed renovations.

The applicant is appearing before the Planning Board to present the project and answer any questions that arise.



TOWN OF NISKAYUNA

One Niskayuna Circle Niskayuna, New York 12309-4381

Phone: (518) 386-4530

Application for Site Plan Review

Applicant (Owner or Agent):	Location:
NameMike Tierney	Number & Street 1 Glen Drive Drive
Address1 Glen Eddy Drive	Section-Block-Lot <u>60.</u> - <u>1</u> - <u>17.3</u>
Niskayuna, NY	
EmailMichael.Tierney@SPHP.com	
Telephone Fax	Zoning District R-1 Low Denisty Residential
Proposal Description:	
The proposed project includes a small addition (929sf) to the covered front entry porch to increase the Library, Vestibule, a fabric roof will be removed and replaced by a new steel frame building. The new canopy will better protect the residents from The dining room addition is required to allow the facility to con There will be no increase in the number of residents and/or standard the facility to confide the	and Office. Additionally, the existing steel frame canopy with a copper roof that matches the existing in the elements as they exit a vehicle. Imply with an Enriched Housing licensure it is seeking. taff.
The area of proposed disturbance is .23acres, and the total in connected to the existing storm sewer system. There is no inc	crease in site utilities required.
Signature of applicant:	Date:
Signature of owner (if different from applican	nt):
Date:	

3-2018 Page **1** of **2**

Each site plan application shall be accompanied by:

- 1. Digital copies in pdf format of all application forms and supporting documents.
- 2. A digital copy in pdf format and three (3) full size copies of any large scale plans or maps prepared by a licensed engineer, architect or surveyor.
 - a. The site plan shall include the following: the title of the drawing, including the name(s), address(es), phone and fax numbers of the applicant and the name address, phone and fax number of the person, firm or organization preparing the map.
 - b. The North point, date and scale.
 - c. Boundaries of the property.
 - d. Existing watercourses and direction of existing and proposed drainage flow.
 - e. The location of all proposed site improvements; proposed water and utility facilities; a description of the method of sewage disposal and location of such facilities; the location of all proposed signs; and location of proposed areas of vegetation.
- 2. A digital copy in pdf format of a lighting plan showing the lighting distribution of existing and proposed lights, specifications, photometric data, and catalog cuts of the proposed fixture(s) which meet the requirements of Article VIIIB of the Zoning Ordinance of the Town of Niskayuna entitled "Guidelines for Lighting of Outdoor Areas under Site Plan Review".
- 3. One (1) copy of the short or long Environmental Assessment Form (EAF), as required by 6NYCRR Part 617, "State Environmental Quality Review", and Chapter 95, "Environmental Quality Review" of the Code of the Town of Niskayuna.
- 4. If the application is being made by someone other than the current property owner, the applicant or the agent for the applicant must provide proof that they are authorized to pursue this site plan approval. Such proof may be in the form of a contract for sale or letter by the current owner that the applicant/agent is authorized to proceed with this application.
- 5. Administration Fees: An application for site plan approval shall be submitted to the Planning Board at least ten (10) business days prior to a regular meeting of the Planning Board. Each petition shall be accompanied by a minimum fee of \$200.00 plus an additional fee based on the square footage of new building construction. Fees are payable to the Town of Niskayuna.
- 6. Consulting Fees: The cost incurred by the Town for the review of an application by the Town Engineer, consulting engineering firm or other consulting fees, in connection with a Board's review of a proposed application shall be charged to the applicant. The Board to whom the application is made shall obtain an estimate from any designated consultant of the amount sufficient to defray the cost of such services and shall collect from the applicant the estimated charges. Any portion of the estimated charges so collected, which are not expended by the Town, shall be returned to the applicant. Any such costs incurred by the Town beyond the estimated charges initially collected from the applicant, shall be collected from the applicant prior to final action upon the application.





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New York 12206
P 518 454 9300
F 518 454 9333

Project
THE TERRACE AT
GLEN EDDY PORTE COCHERE
& DINING ROOM
ADDITIONS

Revisions

SCH4.4

SCHEME 4



03/10/22

THE TERRACE AT GLEN EDDY - PORTE COCHERE & DINING ROOM ADDITIONS

One Ascot Lane Niskyuna, NY 12309

Site Plan Review Set May 03, 2022

Owner

Glen Eddy Retirement Community One Ascot Lane Niskyuna, NY 12309

Architect

Angerame Architect, P.C. 30 Essex St, Albany, NY 12206 Phone: (518) 454-9300 Fax: (518) 454-9333

Consultants

Mechanical/Plumbing/Electric Engineer: Engineered Solutions 646 Plank Rd. #104 Clifton Park, NY 12065 Phone: (518) 280-2410

Structural:
MRH Engineering, P.C.
20 Bayberry Drive, Queensbury, NY 12804
Ph: (518) 792-4042 Cell: (518) 796-6054

BUILDING INFORMATION

Building Type: 5B
Building Construction Type: Existing I-1, Condition 2
No. of Stories: 2

CODE REFERENCES

NFPA 101, Life Safety Code, 2012 Edition Chapter 33 "Existing Residential Board & Care Facility" Chapter 43 "Building Rehabilitation"

ICC/ANSI A117.1-2009 "Accessible and Usable Buildings and Facilities"

Uniform Federal Accessibility Standards (UFAS)

2010 ADA Standards for Accessible Design, Title II-3 - Department of Justice

2020 International Building Code, Existing Building Code, Fire Code, Mechanical Code, Plumbing Code, Energy Code (As adopted by New York State)

Drawing List

C101	EXISTING SITE PLAN		
C102	SITE GRADING PLAN		* *.
C103	SITE UTILITY PLAN		
C104	SITE LAYOUT PLAN		
C105	SITE PLANTING PLAN	* .	
C106	SITE DETAILS	•	
C107	SITE DETAILS	•	
C108	SITE DETAILS		74
C109	EROSION CONTROL DETAILS & NOTES		



NOT FOR CONSTRUCTION

-Site Plan Review Set-

SITE LOCATION MAP

N.T.S.

The Terrace at Glen Eddy



GENERAL SITE WORK NOTES

1. ALL WORK SHALL BE DONE IN STRICT COMPLIANCE WITH ALL APPLICABLE NATIONAL, STATE AND LOCAL CODES, STANDARDS, ORDINANCES, RULES AND REGULATIONS.

2. EXISTING UTILITY INFORMATION SHOWN HEREON WAS TAKEN FROM PREVIOUS RECORD DATA. THEIR EXACT LOCATION IN THE FIELD MAY DIFFER FROM THAT SHOWN HEREIN AND ADDITIONAL UTILITIES MAY EXIST. CALL UNDERGROUND FACILITIES PROTECTIVE ORGANIZATION TO HAVE UTILITIES MARKED ON SITE PRIOR TO COMMENCEMENT OF CONSTRUCTION.

3. THE ARCHITECT/ENGINEER RESERVES THE RIGHT TO EXAMINE ANY WORK DONE ON THIS PROJECT AT ANY TIME TO DETERMINE THE CONFORMANCE WITH THE REQUIREMENTS OF THE CONTRACT DOCUMENTS OF THIS PROJECT, AS INTENDED AND INTERPRETED BY THE

4. MISCELLANEOUS WORK NOT SPECIFICALLY SHOWN ON THE CONTRACT DRAWINGS SUCH AS PATCHING, BLOCKING, TRIMMING, ETC. SHALL BE PERFORMED AS REQUIRED TO MAKE THE WORK COMPLETE.

5. ALL DISTURBED AREA TO RECEIVE TOPSOIL AND SEED.

7. THE CONTRACTOR SHALL:

A. VERIFY ALL CONDITIONS IN THE FIELD PRIOR TO COMMENCEMENT OF WORK AND NOTIFY THE ENGINEER OF ANY DISCREPANCIES.

B. EXAMINE THE SITE AND INCLUDE IN HIS WORK THE EFFECT OF ALL EXISTING CONDITIONS ON THE WORK. C. PROVIDE AND INSTALL ALL MATERIALS AND PERFORM ALL MORK IN ACCORDANCE WITH RECOGNIZED GOOD STANDARD PRACTICE.

D. COMMENCE WORK IMMEDIATELY UPON AWARDING OF THE CONTRACT AND PROCEED DILIGENTLY AND CONTINUALLY TO COMPLETION OF ALL WORK. E. PROVIDE CERTIFICATE OF INSURANCE ACCEPTABLE TO THE OWNER PRIOR TO

COMMENCEMENT OF THE WORK. F. HOLD THE OWNER AND ARCHITECT HARMLESS AGAINST ANY AND ALL CLAIMS ARISING FROM WORK DONE BY THE CONTRACTOR ON THE SITE.

OVERALL EXISTING SITE PLAN

1" = 200' - 0"

LEGEND

CONTRACT ACCESS

PROPERTY LINES

CONTRACT LIMIT LINES

CONTRACT STAGING AREA

AREA OF CONSTRUCTION

MECHANICAL COMPACTOR BETWEEN LIFTS.

9. WHEN BACKFILLING AROUND PROPOSED OR EXISTING STRUCTURES, MATERIAL SHALL BE PLACED IN MAXIMUM SIX (6) INCH LIFTS AND COMPACTED BY MEANS OF A COMPACTOR BETWEEN LIFTS.

8. ALL BACKFILL USED IN TRENCHES EXCAVATED IN EXISTING ROADWAYS SHALL

BE PLACED IN MAXIMUM SIX (6) INCH LIFTS AND COMPACTED BY MEANS OF A

10. PROVIDE EROSION CONTROL MEASURES TO PREVENT EROSION OR DISPLACEMENT OF SOILS AND DISCHARGE OF SOIL BEARING WATER RUNOFF OR AIRBORNE DUST TO ADJACENT PROPERTIES AND WALKWAYS. THIS WILL INCLUDE BUT NOT LIMITED TO HAY BALES, SILTATION FENCES AND OTHER ACCEPTABLE METHODS OF EROSION CONTROL. THE INTENT OF THESE MEASURES IS TO INSURE THE PREVENTION OF SILTATION OF WATER COURSES DOWN STREAM FROM THIS PROJECT IN COMPLIANCE WITH THE NEW YORK STATE DEPARTMENT OF ENVIRONMENTAL CONSERVATION "GENERAL PERMIT FOR STORM WATER DISCHARGE ASSOCIATED WITH INDUSTRIAL ACTIVITY FROM CONSTRUCTION

11. ALL VEHICLES HAULING MATERIAL SHALL BE EQUIPPED WITH CANVAS COVERS TO PREVENT DUST AND LOOSE MATERIAL FROM EXISTING THE VEHICLE.

12. THE CONTRACTOR IS RESPONSIBLE FOR THE IMPLEMENTATION AND CONFORMANCE TO THE "NEW YORK GUIDELINES FOR URBAN EROSION & SEDIMENT CONTROL" AS PREPARED BY THE U.S. DEPARTMENT F AGRICULTURE SOIL CONSERVATION SERVICE. THE CONTRACTOR IS RESPONSIBLE FOR INFORMING ALL CONSTRUCTION WORKERS INVOLVED IN THE SITE DEVELOPMENT OF THE IMPORTANCE AND ELEMENTS OF THE PLAN.

13. ALL EXISTING DRAINAGE MUST BE MAINTAINED.

CONTRACT LIMIT LINES

-CONTRACT STAGING AREA

PROTECTIVE FENCING

14. CONTRACTOR SHALL USE DUST CONTROL MEASURES DURING CONSTRUCTION. 15. ACCESS TO EXISTING BUILDING SHALL BE MAINTAINED COMPLETELY DURING DURATION OF PROJECT.

1" = 10'-0"

400.9 DOOR SILL 2 STORY WOOD FRAME BUILDING REMOVE ALL PLANTS, TREES & ---REMOVE EXIST. STONE PLANTING BEDS AS REQ'D. FOR BORDER AS REQ'D. FOR NEW CONSTRUCTION (TYP.) NEW CONSTRUCTION (TYP.) REMOVE EXIST. STONE -BORDER AS REQ'D. FOR EXIST. STONE BORDER MULTI-PURPOSE NEW CONSTRUCTION (TYP.) ROOM F.F. 401.00± FFE=401.0 REMOVE EXIST. C.B. & PREP EXIST. PIPE TO FOOTING DRAIN CONNECTION SPLICE & EXTEND **GRASS** INV=396.9 2 STORY WOOD - INV=396.9 FRAME BUILDING RELOCATE EXIST. LIGHT REMOVE ALL PLANTS, TREES & - INV=398.79 POLE AS REQ'D. PLANTING BEDS AS REQ'D. FOR NEW CONSTRUCTION (TYP.) REMOVE & REPLACE -CONC. EXIST. CONC. WALK AS CONC. PER NEW LAYOUT REMOVE EXIST. SIGNAGE & RELOCATE AS PER REMOVE & REPLACE EXIST. OWNER'S INSTRUCTIONS SIDEWALK, CURB & RAMP AS PER NEW LAYOUT REMOVE EXIST. CANOPY & STRUCT. **GRASS** REMOVE & REPLACE EXIST. SIDEWALK & CURB TF=400.0 EXIST. RETAINING WALL -REMOVE & REPLACE EXIST remove a replace AS PER NEW LAYOUT SIDEMALK, CURB/&/RAMR) EXIST. CONC. WALK AS AS PER NEW LAYOUT PER NEWLAYOUT (TYP.) \REMOVE\&\ , exisithe storm semer line to REINSTALL EXIST ASPHALT BE ABANDONED! OUT BACK OUT 411.6 X shehal as reqip. \OF\ADDITION FOOTPRINT\&\FILL\ END/W/CONORETE/_____ TREES & STUMPS TO BE REMOVED AS REQ'D. (TYP.) REMOVE & REPLACE EXIST. SIDEWALK, CURB & RAMP REMOVE EXIST AS PER NEW LAYOUT CURB AS SHOWN " EXIST. STRIPING LEXIST. ROAD TO TO BE REPAINTED BE MILLED & GRASS REPAIRED ' PREGSURE WASH EXIST, GRANTE ' CURBING IN MORK AREA (TXP.) SAM GUT EXIST. , RAVEMENT ASPHALT REALIGN \ EXIST. CURB EXIST. TO REMAIN FLAGPOLE EXIST, STRIPING CONTRACT LIMIT EXIST. ROAD TO TO BE REPAINTED LINE - PROTECTIVE BE WILLED & FENCING/ REPAIRED REMOVE & RESET SMOOTH CUT RADIUS SAW CUT EXIST. PAVEMENT EXISTING & REMOVALS SITE PLAN

<u>A</u>ngerame Architects, P.C. Architecture Planning Interior Design

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Project

THE TERRACE AT GLEN EDDY -PORTE COCHERE & DINING ROOM **ADDITIONS**

One Ascot Lane Niskyuna, NY 12309

Site Plan Review Set

Consultants

Mechanical/Plumbing/Electric Engineer: Engineered Solutions 646 Plank Rd. #104 Clifton Park, NY 12065

Structural: MRH Engineering, P.C.

Phone: (518) 280-2410

20 Bayberry Drive, Queensbury, NY 12804 Ph: (518) 792-4042 Cell: (518) 796-6054

Revisions


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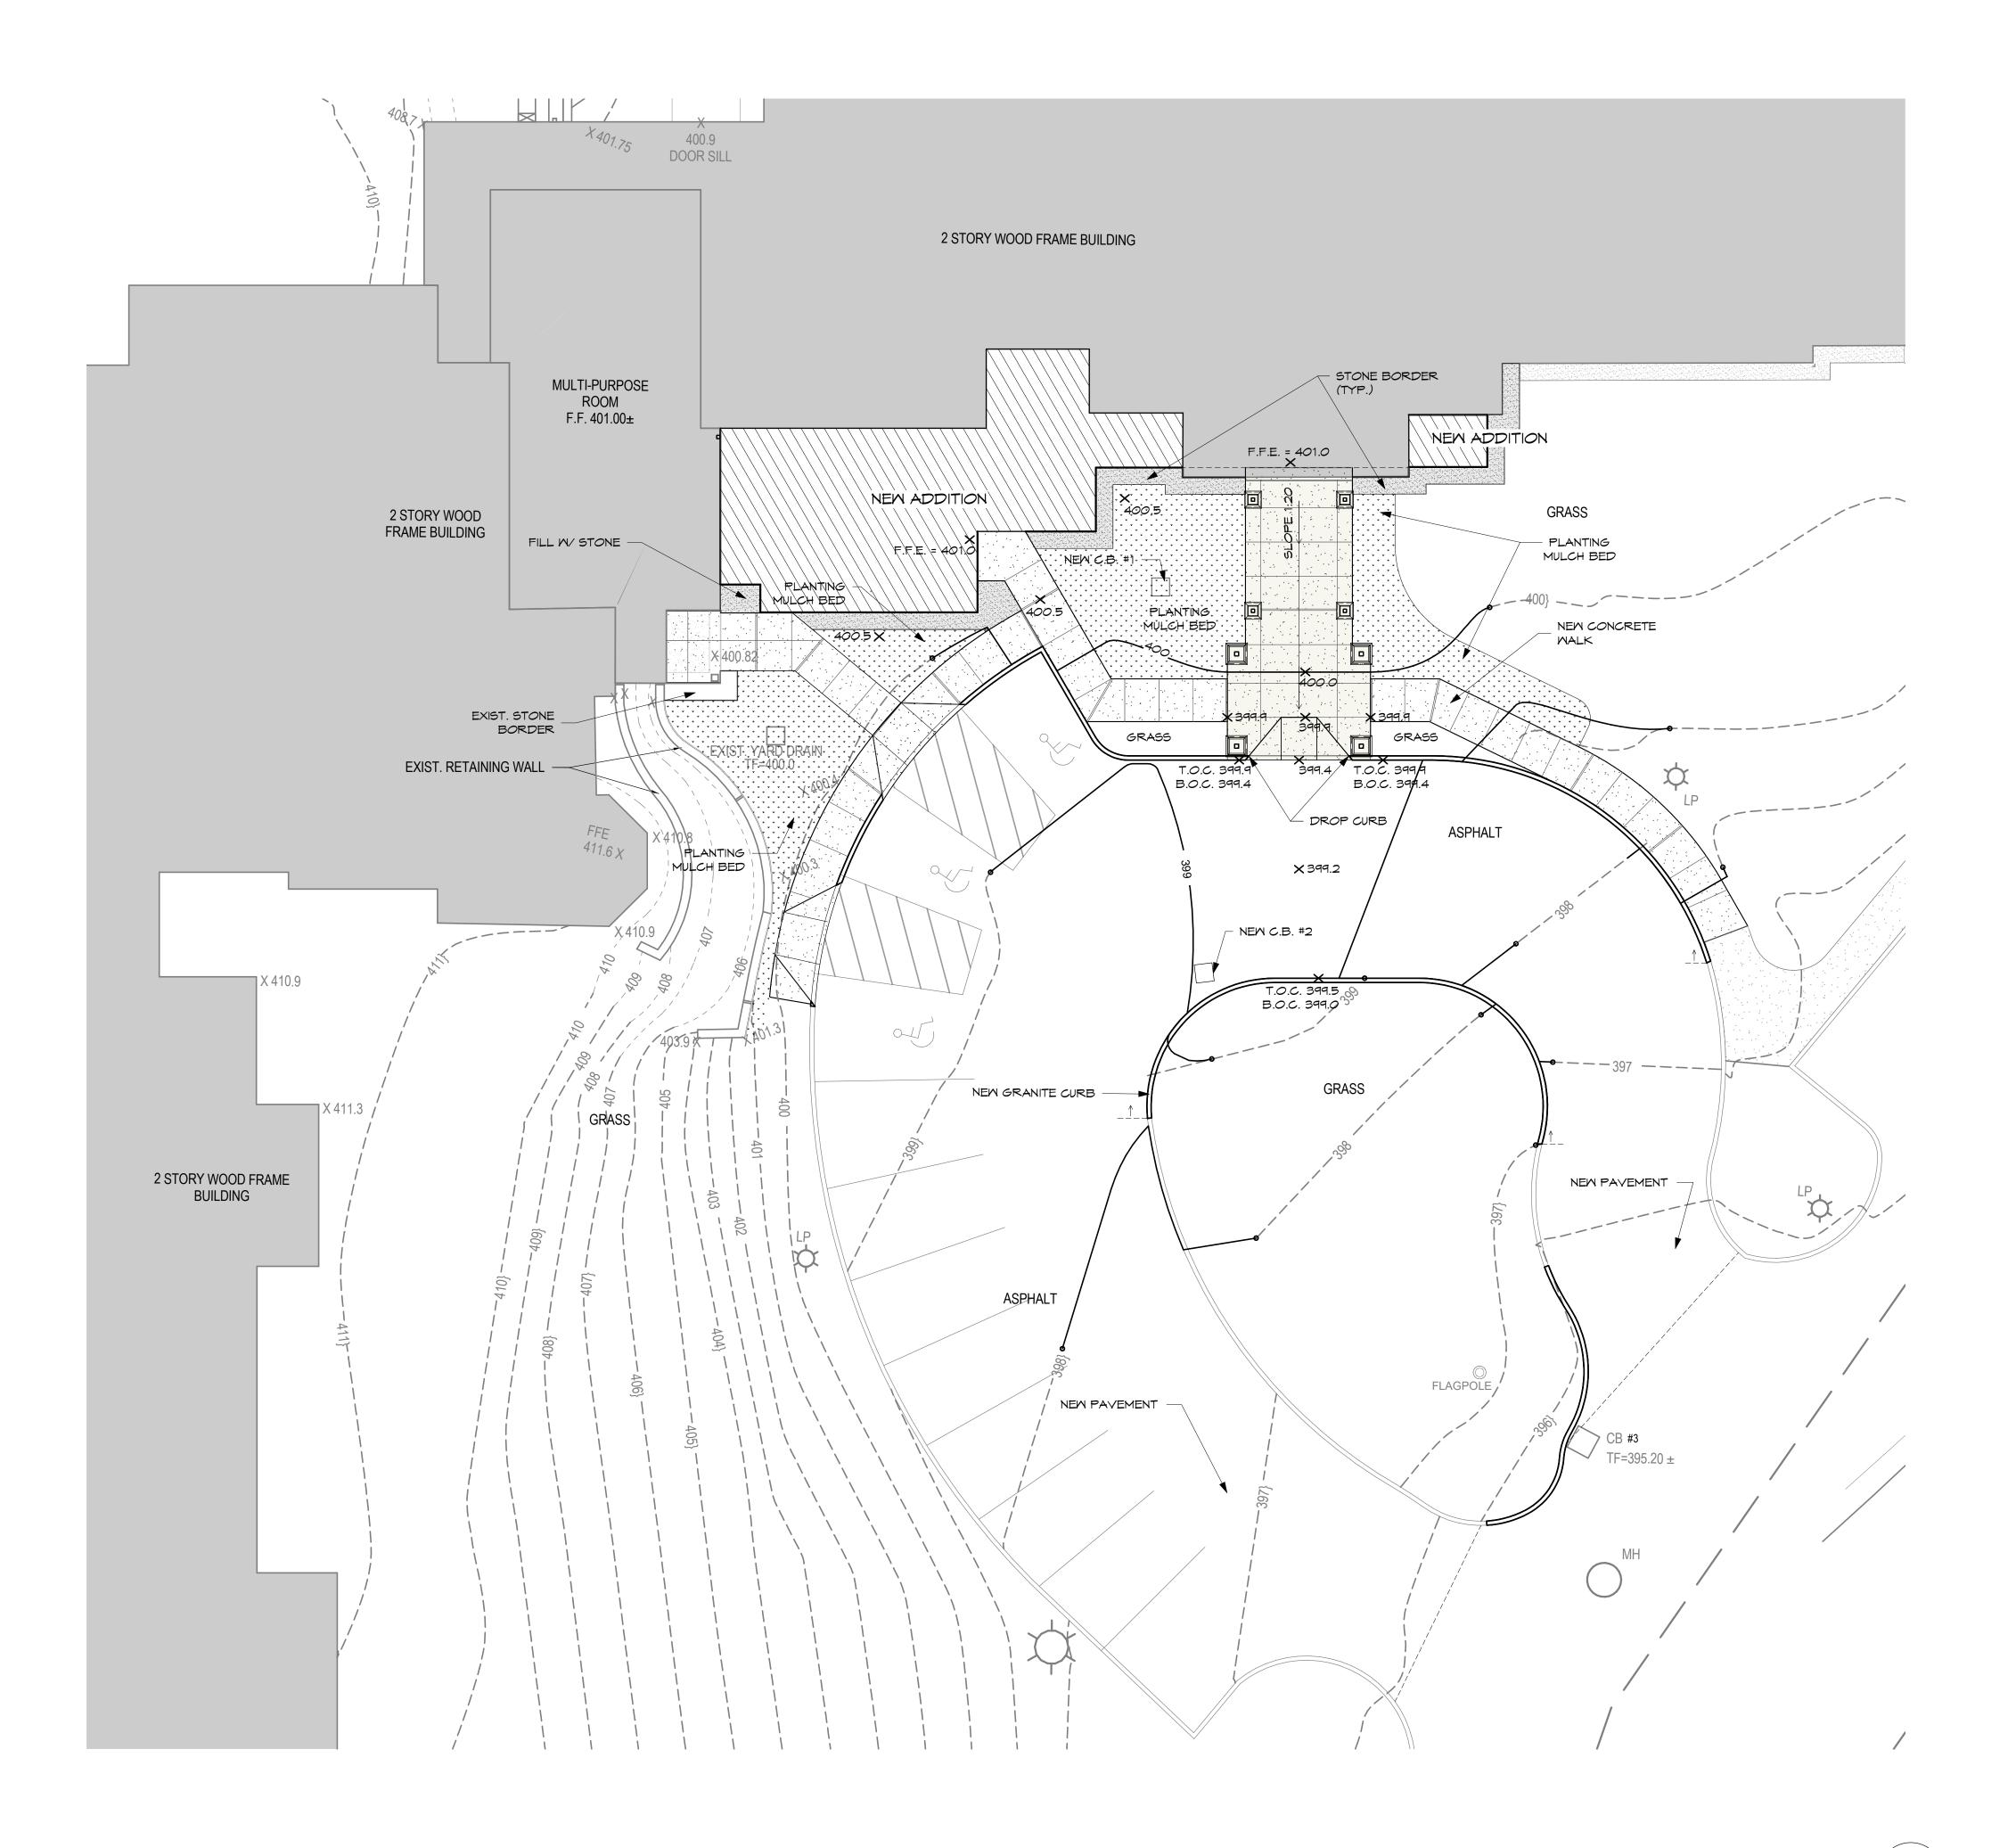
EXISTING SITE PLAN

Drawing Number

C101

C 101



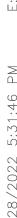

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SITE GRADING PLAN

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Drawing Number

C102

C 102

Date: **May 03, 2022**

SITE GRADING PLAN

1" = 10'-0"

SITE UTILITY PLAN

1" = 10'-0"



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SITE UTILITY PLAN

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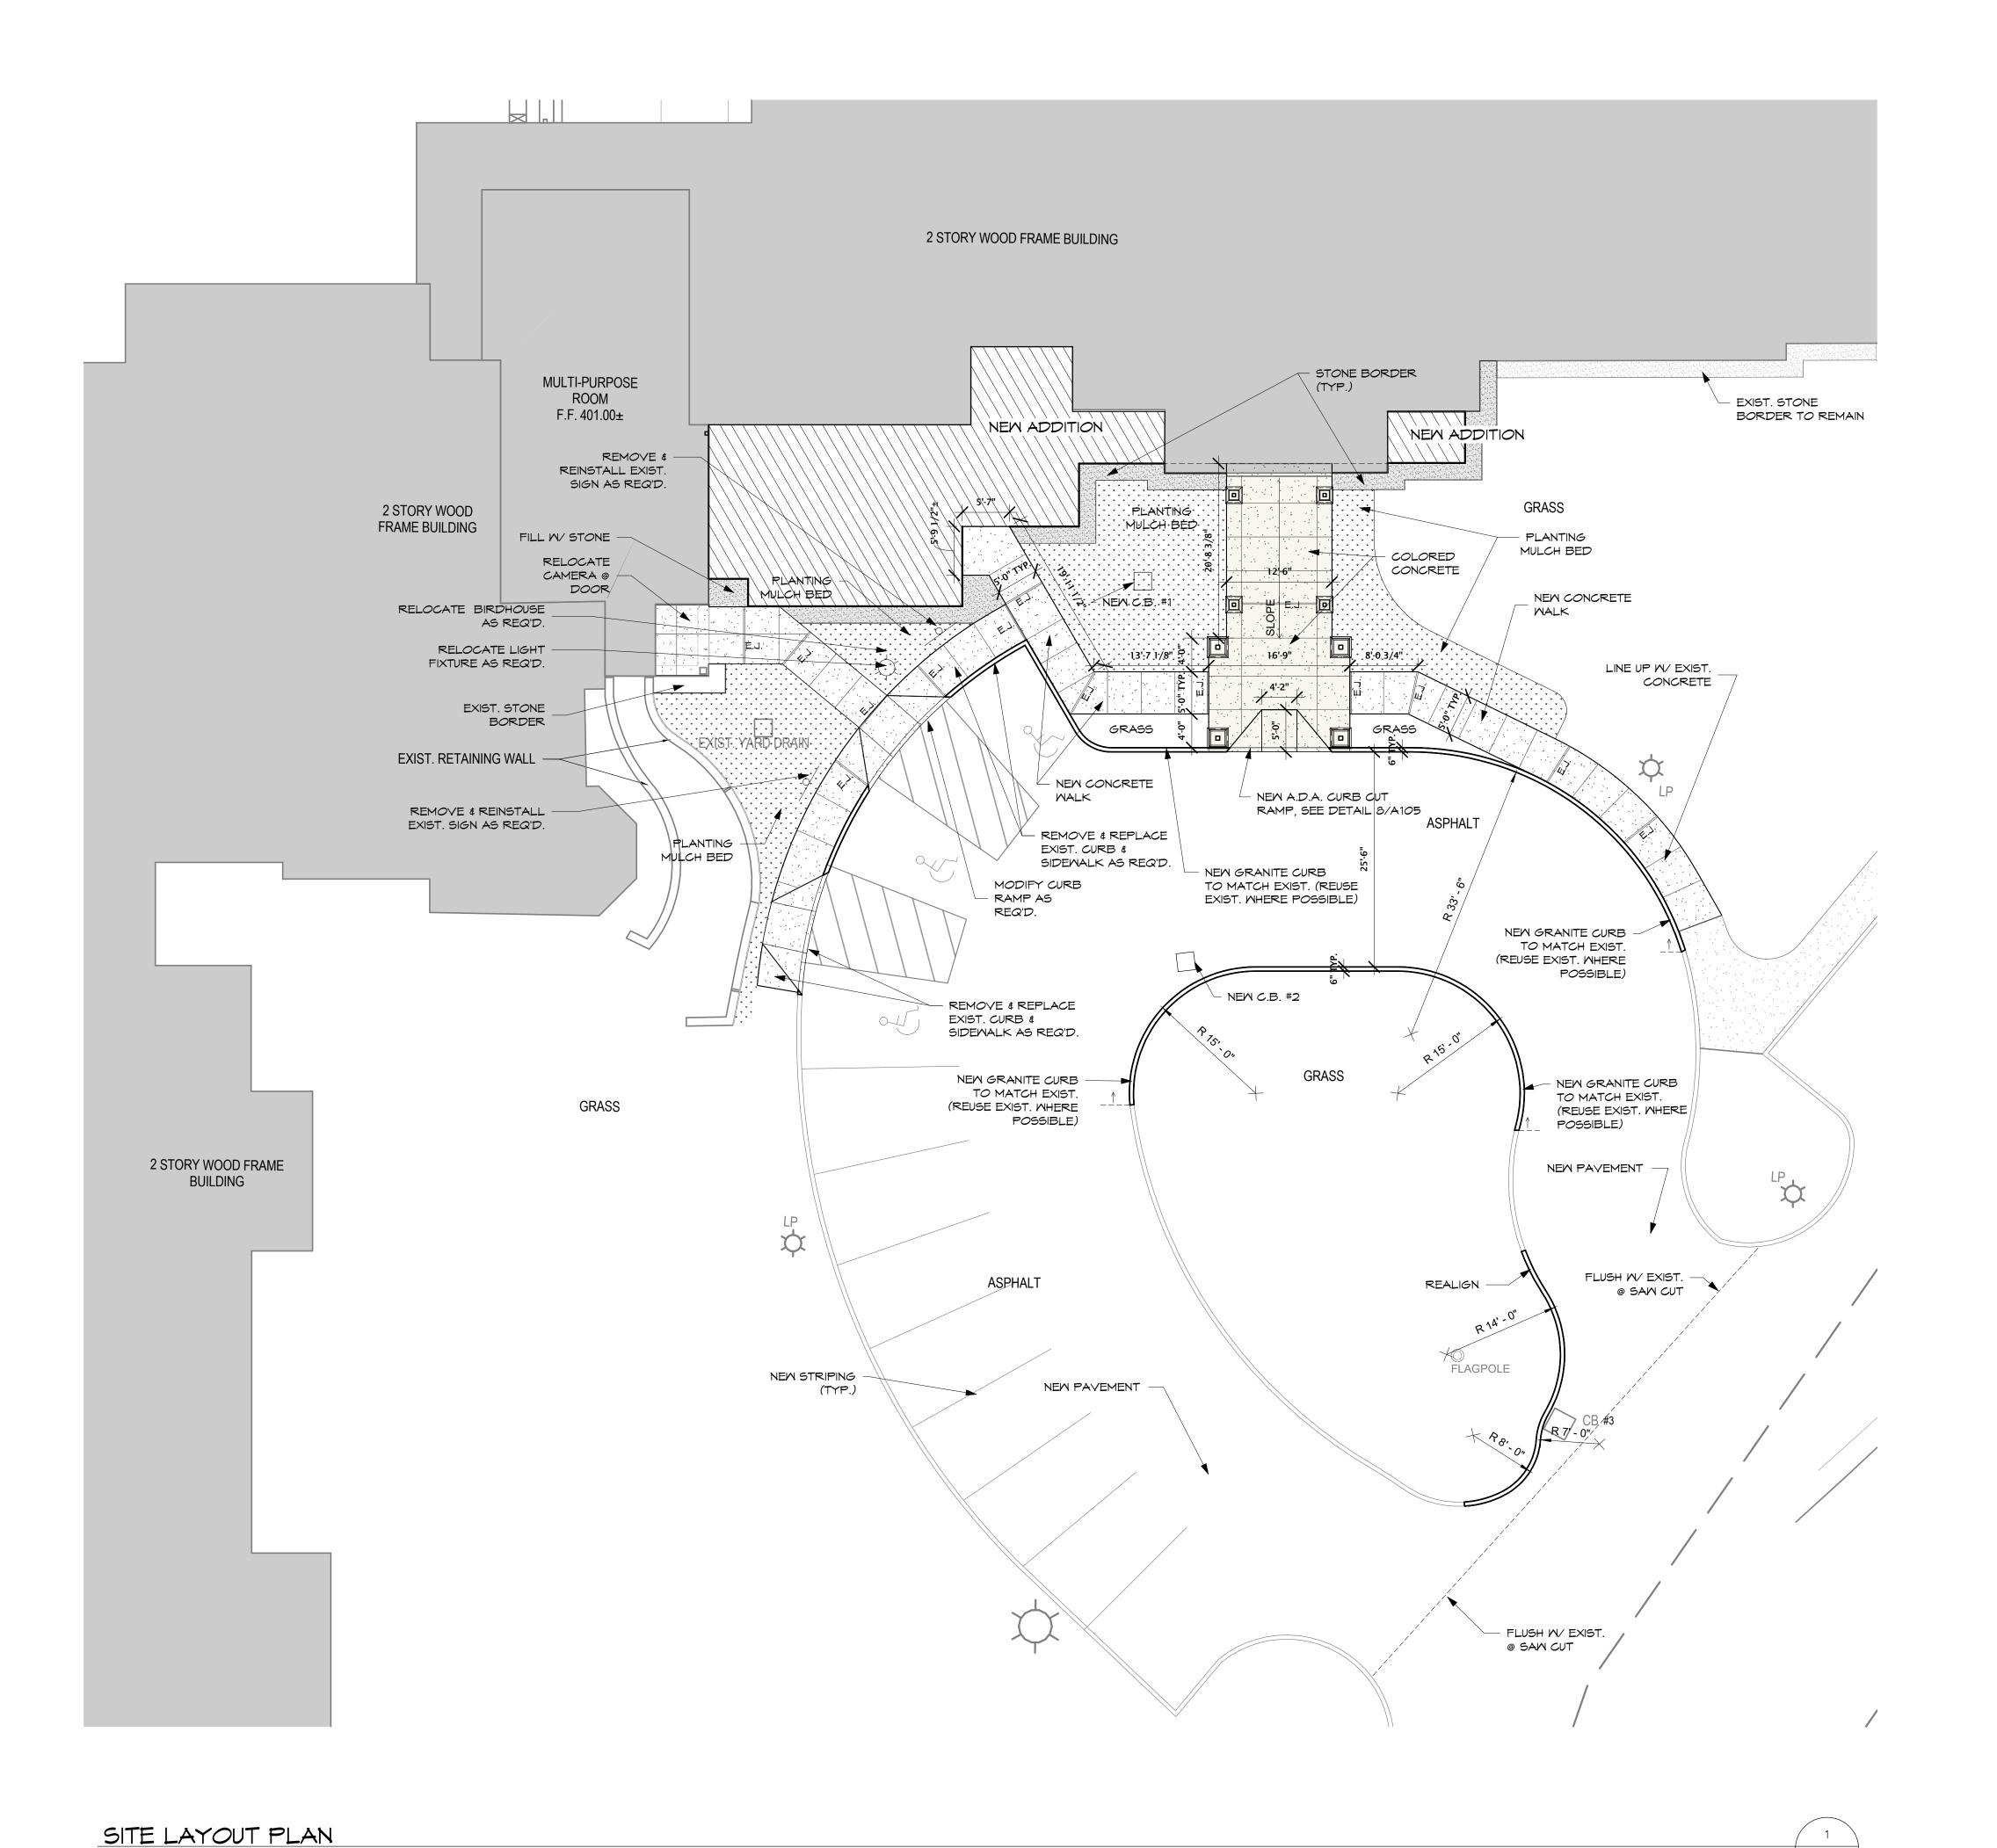
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C 103

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1" = 10'-0"



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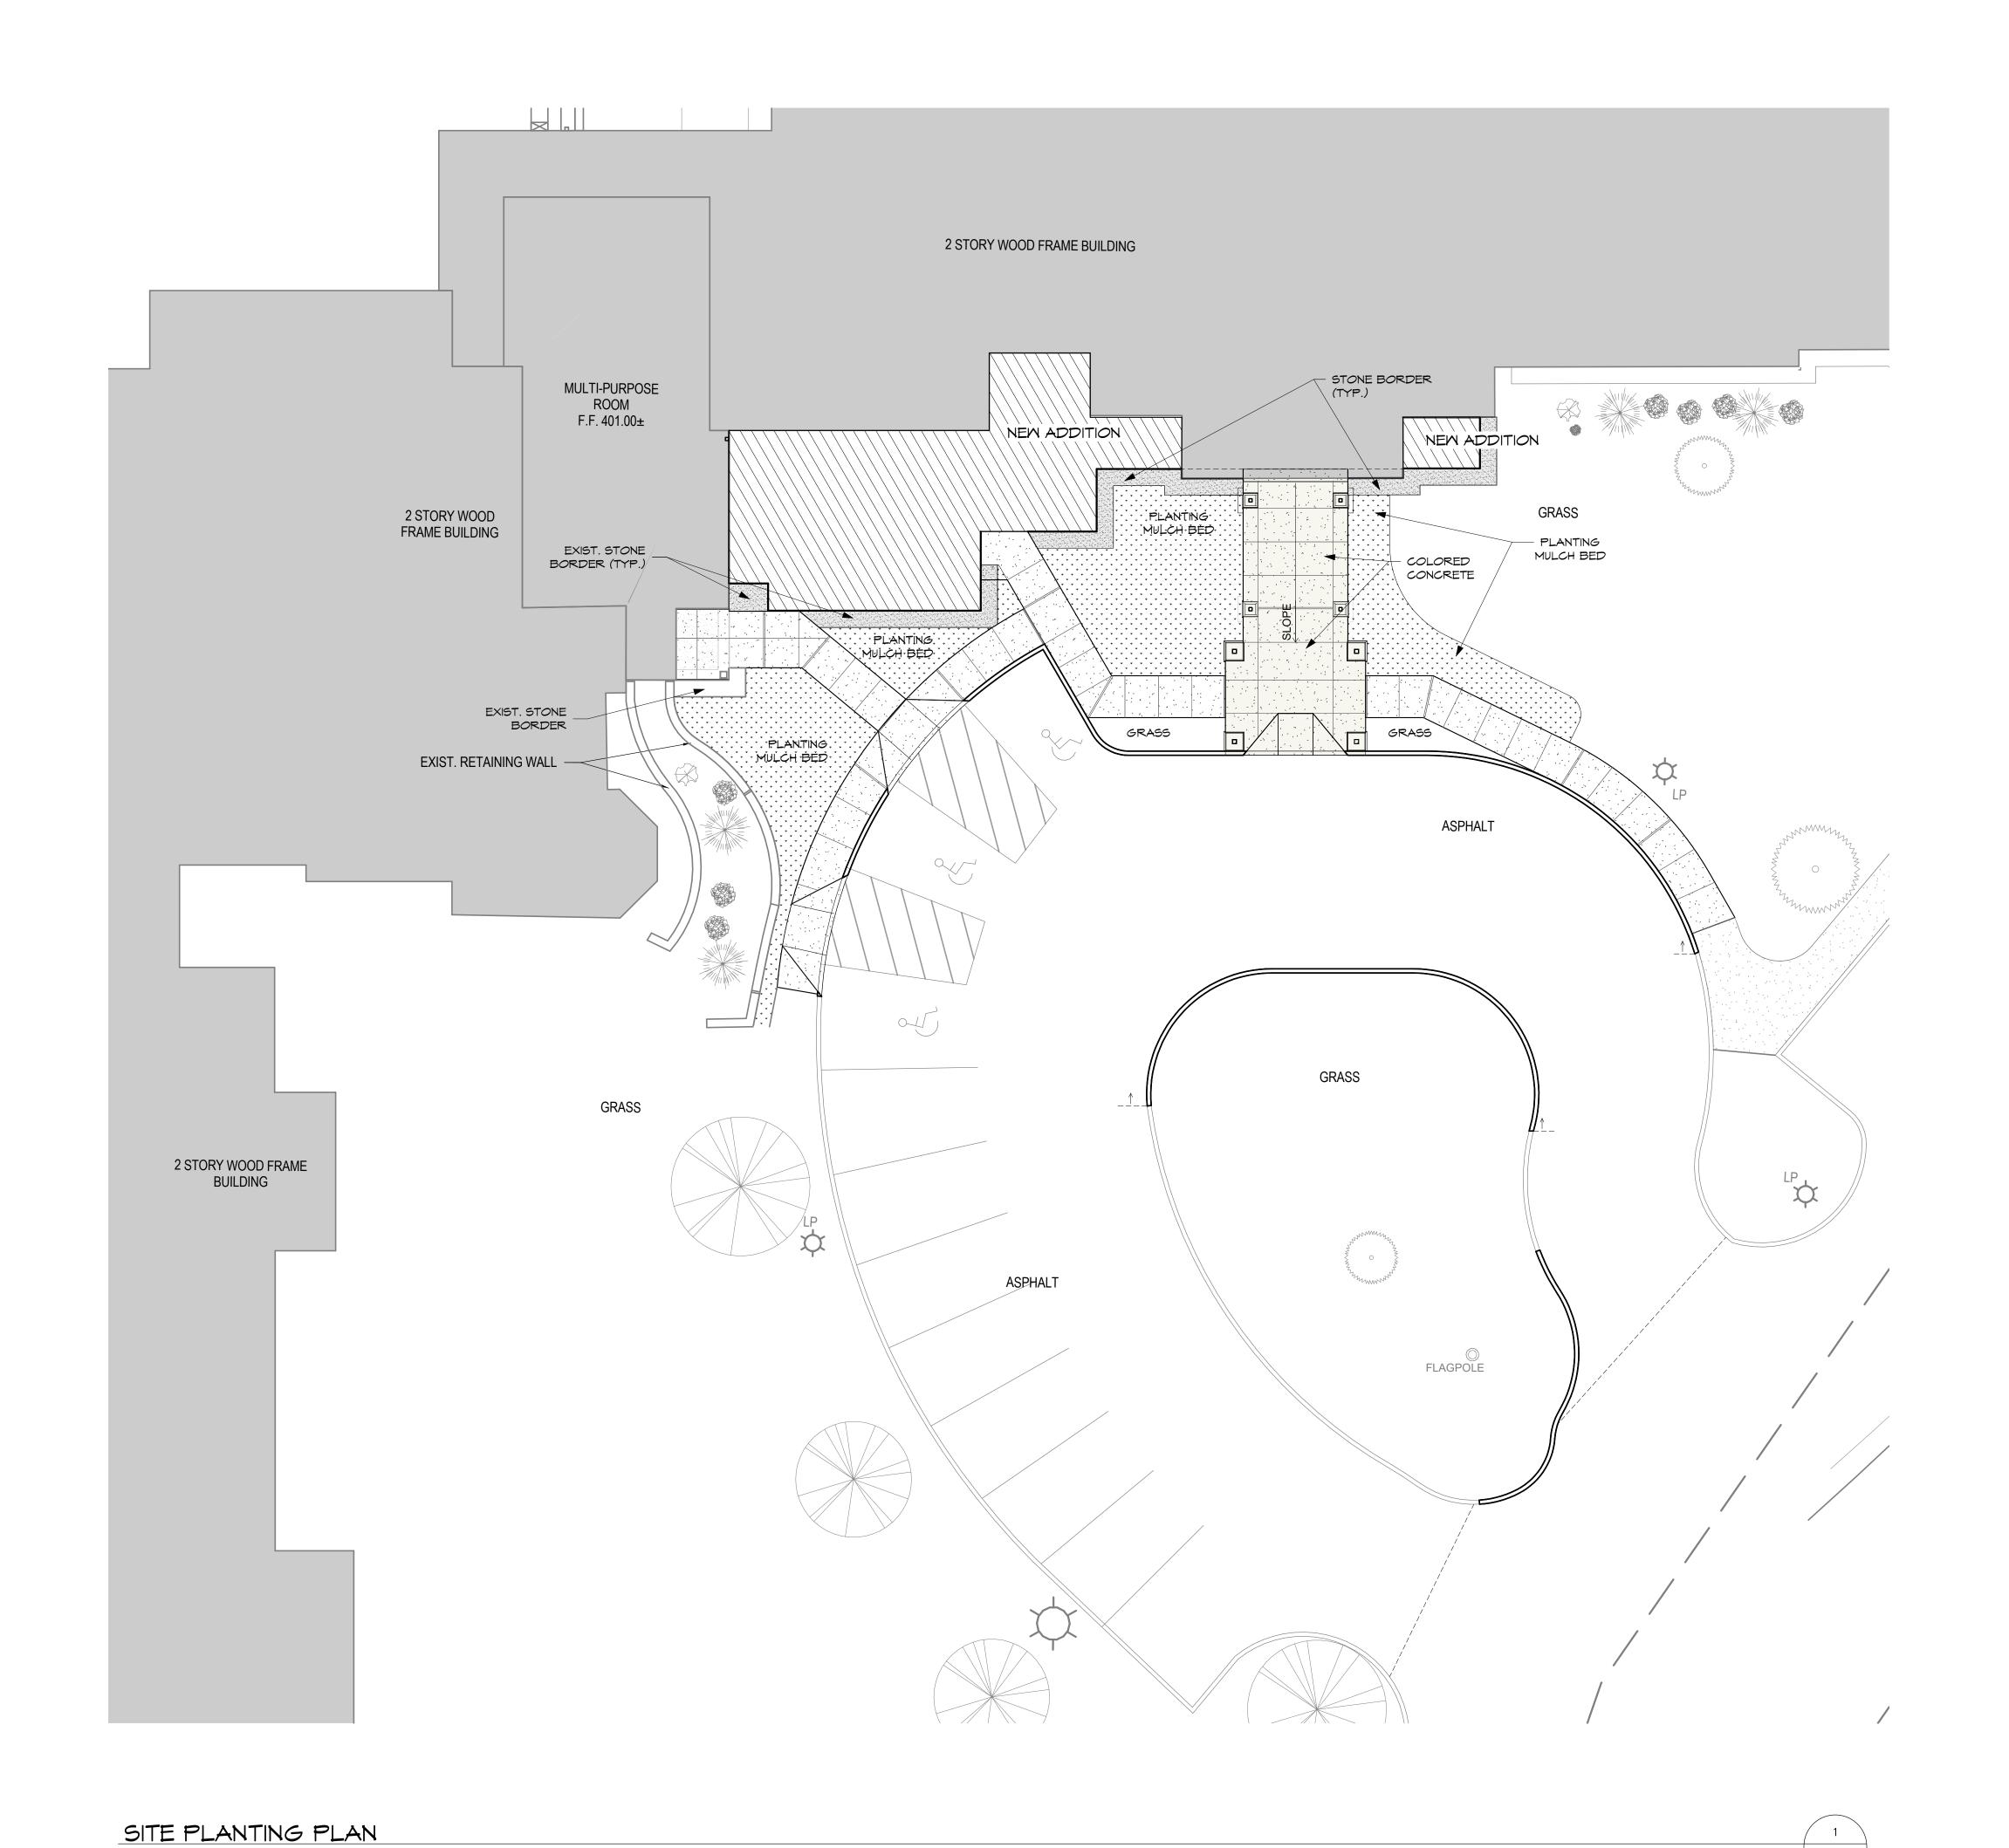
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C 104

C104



1" = 10'-0"



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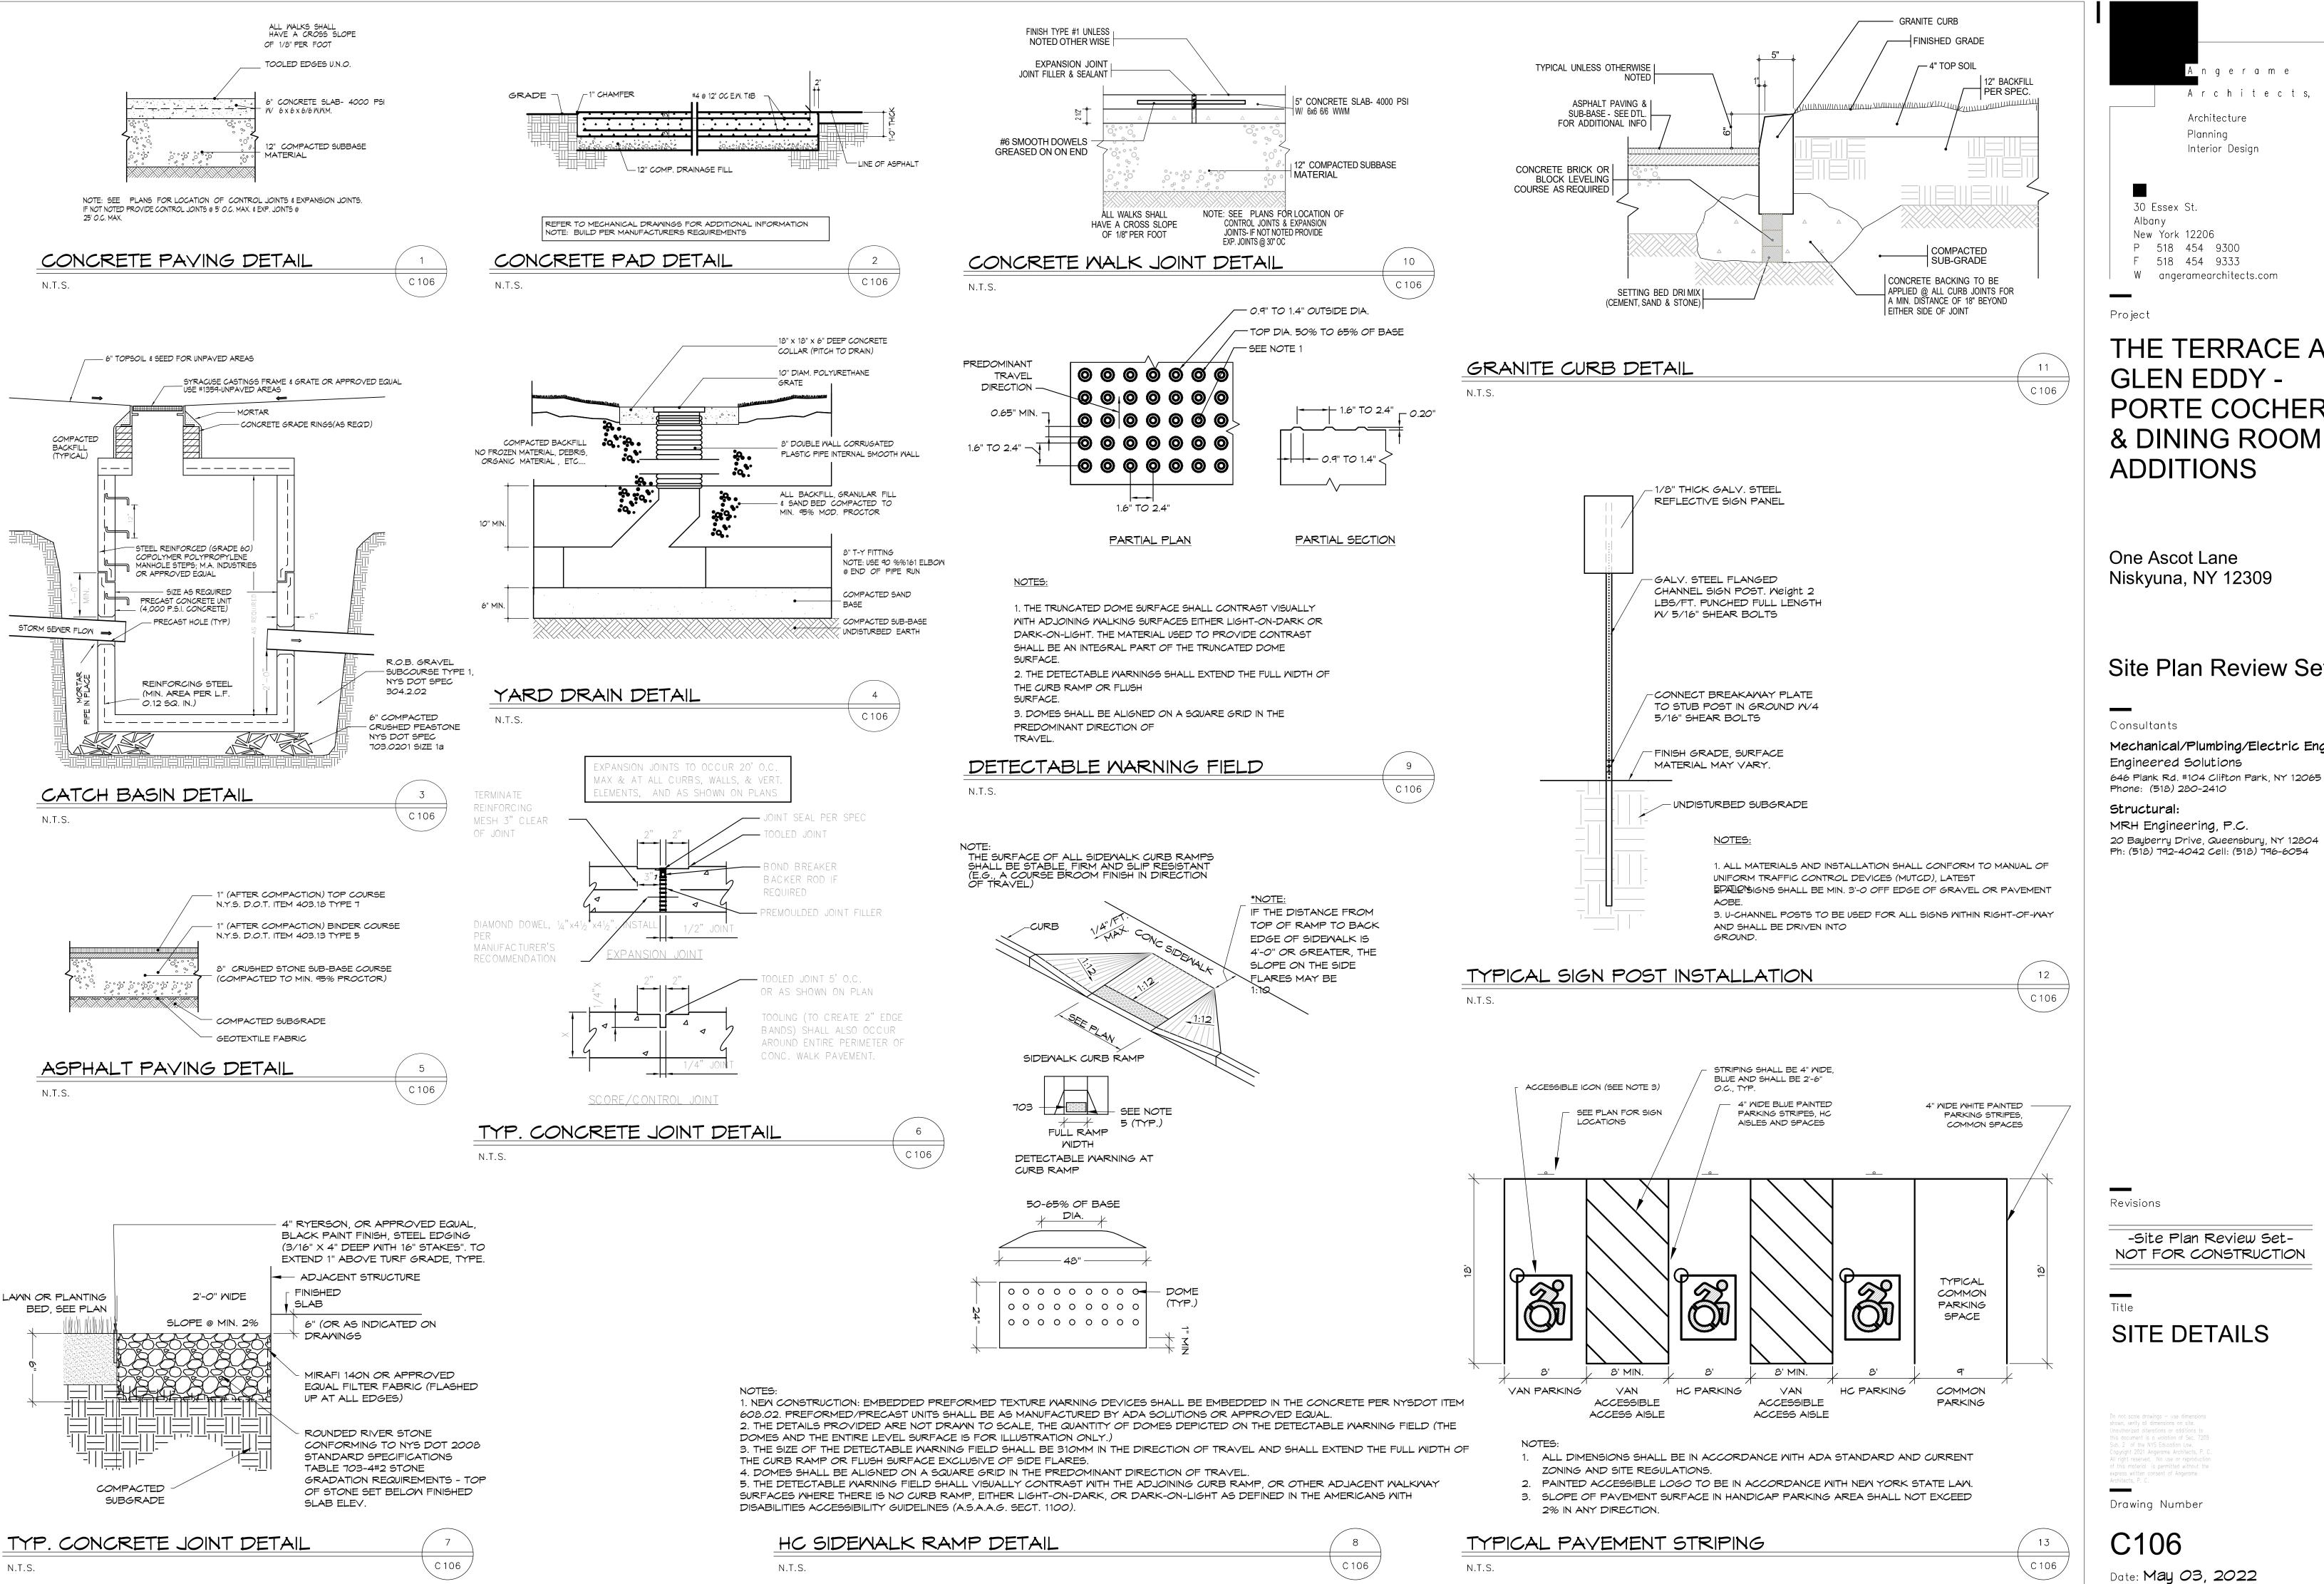
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C 105



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> THE TERRACE AT GLEN EDDY -PORTE COCHERE & DINING ROOM **ADDITIONS**

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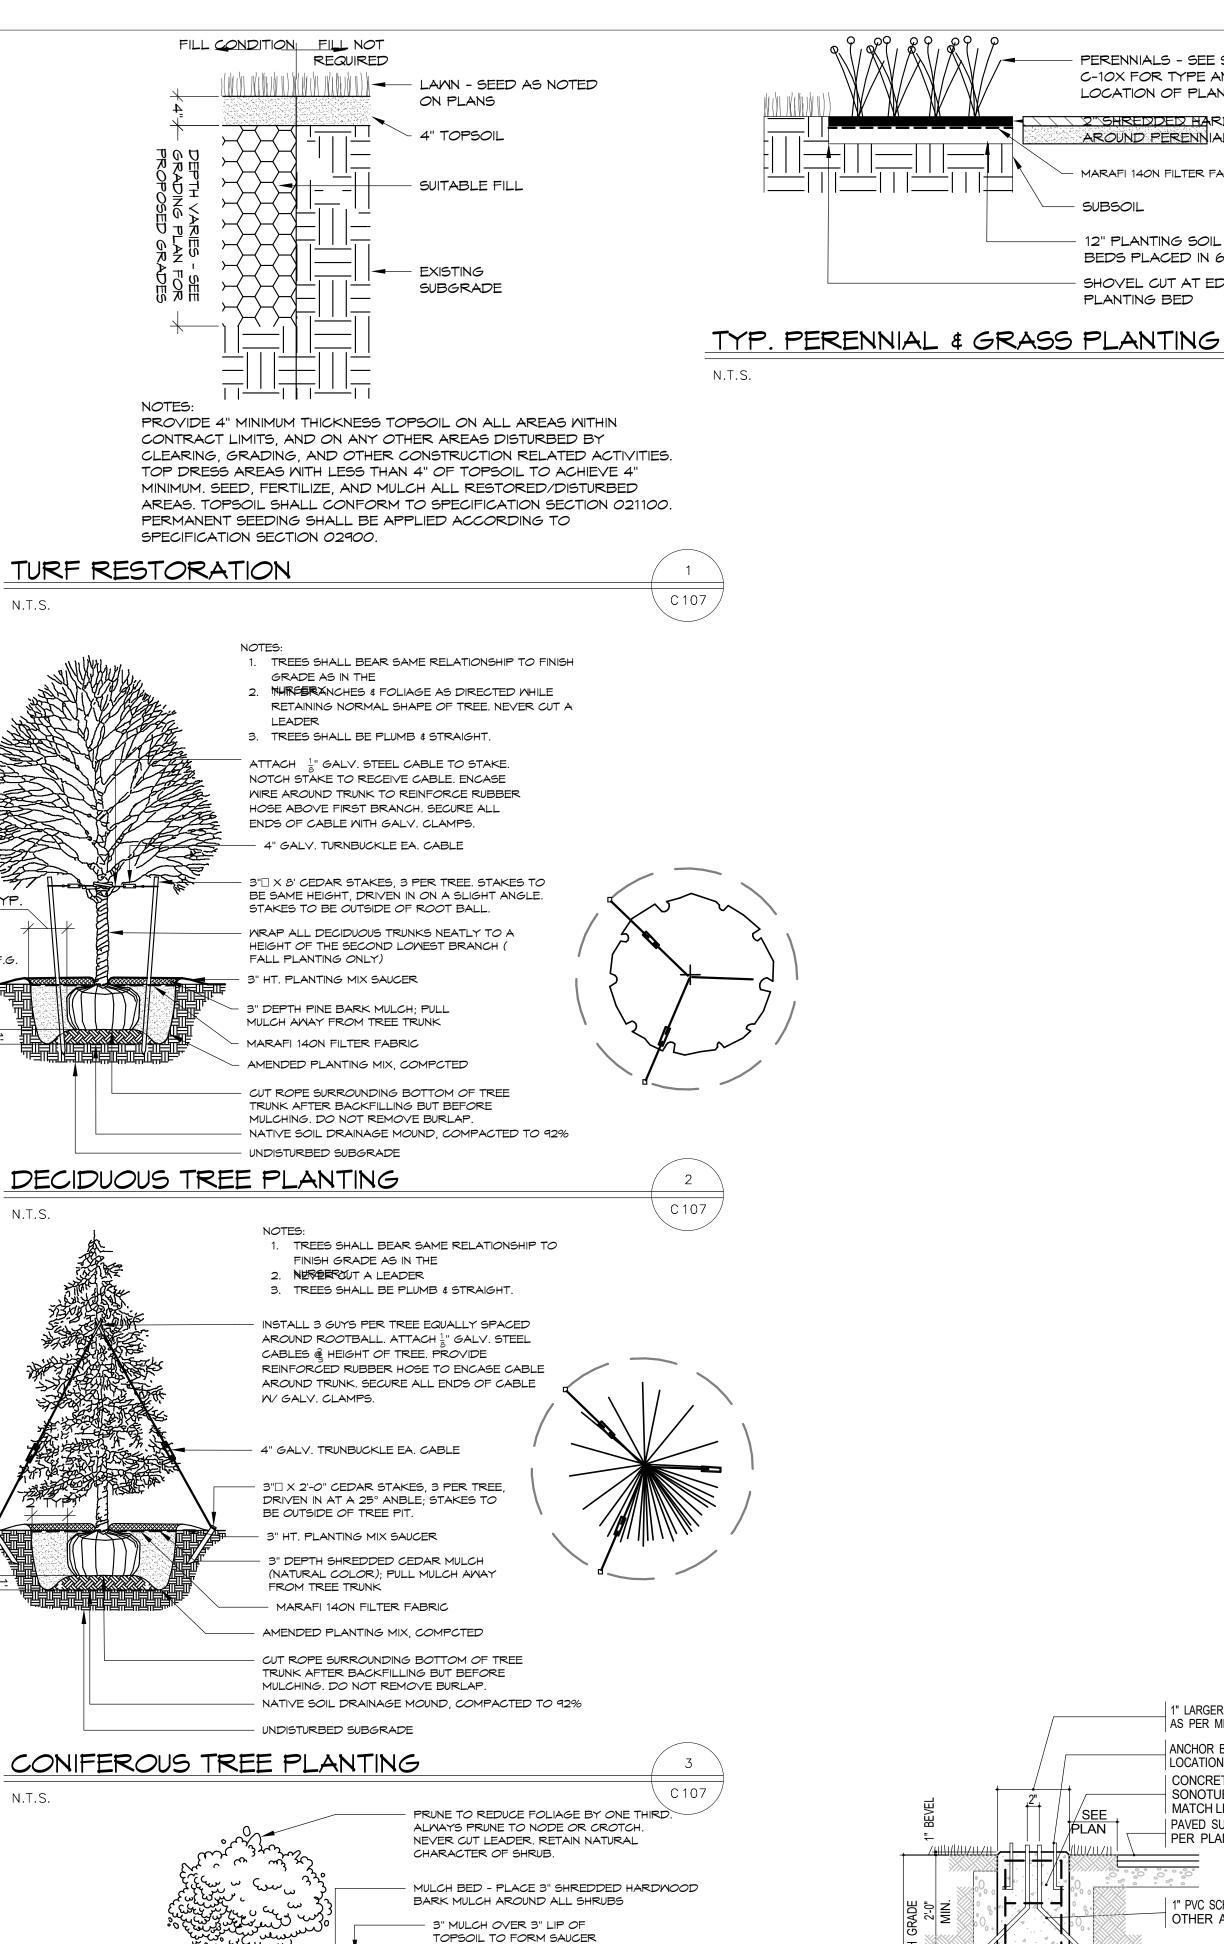
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SITE DETAILS

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Drawing Number

C106



MARAFI 140N FILTER FABRIC

CUT AND REMOVE BURLAP FROM

TOP ONE THIRD OF SHRUB BALL

PREPARED TOPSOIL IN

SCARIFY COMPACTED SUB-SOIL TO A DEPTH OF


6" LIFTS

BORE TO PREVIOUSLY EXISTING GRADE.

1. REFER TO SPECIFICATION SECTION 02900 (PLANTS) FOR

INFORMATION REGARDING PLANTING PROCEDURES. 2. SHRUB ALL BEAR SAME RELATION TO FINISHED GRADE AS IT

BALLED & BURLAPPED SHRUB PLANTING

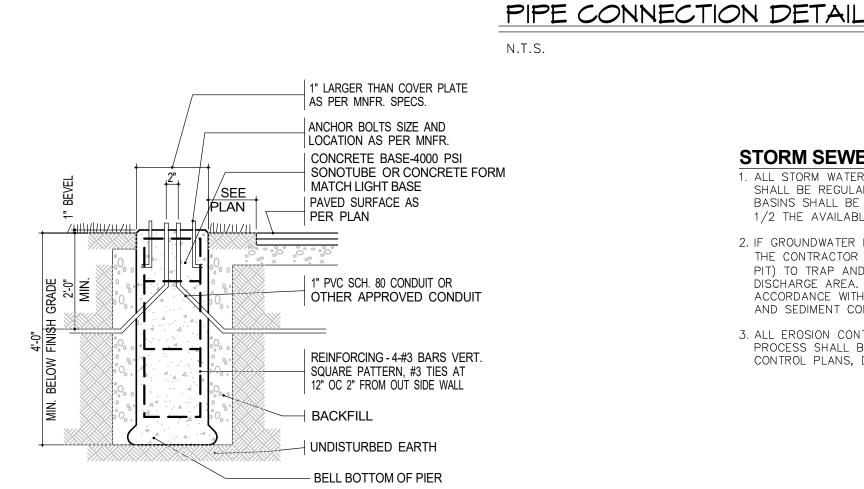

PERENNIALS - SEE SHEET

LOCATION OF PLANTING

MARAFI 140N FILTER FABRIC

SUBSOIL

2" SHREDDED HARDWOOD BARK MULCH

AROUND PERENNIALS AND GRASS SPRIGS

12" PLANTING SOIL MIX IN ALL PERENNIAL

C 107

N.T.S.

PIPE TYPE & SIZE VARIES. SEE PLAN

FOLLOWING GRADATION REQUIREMENTS:

FOLLOWING GRADATION REQUIREMENTS:

COMPACTED TO 90% MODIFIED PROCTOR.

MAINS ONLY (UNLESS OTHERWISE NOTED).

INSIDE FACE OF

STRUCTURE -

NON-SHRINK CEMENT

AGENT IF REQ'D) -

INTO MANHOLE AT

PIPE SPRINGLINE -

BASE SLAB

GROUT (USE BONDING

2" MAX PROJECTION

TYPICAL PIPE TRENCH DETAIL

SIEVE DESIGNATION

SIEVE DESIGNATION

NO. 200

NO. 40

NO. 200

. PIPE BEDDING & PIPE ZONE BACKFILL SHALL BE A NATURAL RUN-OF-BANK

GRADATIONS SHALL BE APPROVED BY THE ENGINEER AND SHALL MEET THE

% PASSING

100%

0-70%

0-10%

PROCESSED GRAVEL, OR EXCAVATED MATERIAL FREE OF SOFT, NONDURABLE PARTICLES, ORGANIC MATERIALS AND ELONGATED PARTICLES, AND SHALL BE

GRADATIONS SHALL BE APPROVED BY THE ENGINEER AND SHALL MEET THE

% PASSING

0 - 70%

100%

IN NON-TRAFFIC UNPAVED AREAS TRENCH BACKFILL CAN BE MATERIALS

3. INSTALL CONTINUOUS DETECTABLE MARKING TAPE DURING BACKFILLING OF

TRENCH FOR UNDERGROUND PIPING. LOCATE TAPE 12" BELOW FINISHED GRADE,

DIRECTLY OVER PIPING, EXCEPT 6" BELOW SUBGRADE UNDER PAVEMENTS &

4. TRENCHING SHALL BE IMPLEMENTED IN ACCORDANCE WITH O.S.H.A. STANDARDS.

5. 5'-0" MIN COVER SHALL BE APPLIED TO WATER MAIN OR SANITARY SEWER

EXCAVATED FROM THE TRENCH AS APPROVED BY THE ENGINEER AND

2. TRENCH BACKFILL SHALL BE A NATURAL RUN-OF-BANK (R.O.B.) OR

WELL GRADED FROM FINE TO COARSE PARTICLES. TRENCH BACKFILL

SHALL BE WELL GRADED FROM FINE TO COARSE PARTICLES. BEDDING

(R.O.B.) SAND OR A MIXTURE OF CRUSHED STONE AND GRAVEL, FREE OF SOFT,

NONDURABLE PARTICLES, ORGANIC MATERIALS AND ELONGATED PARTICLES, AND

BEDS PLACED IN 6" LIFTS (TYP.)

SHOVEL OUT AT EDGE OF

PLANTING BED

C-10X FOR TYPE AND

STORM SEWER NOTES:

FINISHED SURFACE IN ACCORDANCE

WITH PLAN & DETAILS (FULL DEPTH

PAVEMENT REPLACEMENT IN PAVED

-DETECTABLE

WARNING TAPE

PER DIG SAFE

TRENCH BACKFILL

MODIFIED PROCTOR

TRENCH BOTTOM

12"+50% O.D.

BACKFILL

∮6"+50% O.D.

BEDDING

COMPACTED TO 95% MODIFIED PROCTOR

(SEE NOTE 2)

COMPACTED TO 95%

PIPE BEDDING & PIPE ZONE

BACKFILL MATERIAL FOR

1. ALL STORM WATER MANAGEMENT STRUCTURES (I.E. CATCH BASIN, ETC.) SHALL BE REGULARLY INSPECTED FOR SEDIMENT ACCUMULATIONS. CATCH BASINS SHALL BE CLEANED WHEN SEDIMENT DEPTH REACHES A MAXIMUM OF 1/2 THE AVAILABLE SUMP DEPTH.

─ OVERSIZE HOLE

- CHECK CATCH BASIN

- PRECAST CONCRETE

C107

BASE SECTION


DETAIL FOR REQUIRED SUMP

INVERT L.

- HDPE OR CMP PIPE

2. IF GROUNDWATER IS ENCOUNTERED DURING CONSTRUCTION ACTIVITIES, THE CONTRACTOR SHALL CONSTRUCT A DEWATERING PIT (A.K.A. SUMP PIT) TO TRAP AND FILTER WATER FOR PUMPING TO A SUITABLE DISCHARGE AREA. THE DEWATERING PIT SHALL BE CONSTRUCTED IN ACCORDANCE WITH THE NEW YORK STATE GUIDELINES FOR URBAN EROSION AND SEDIMENT CONTROL, LATEST EDITION.

3. ALL EROSION CONTROL MEASURES EMPLOYED DURING THE CONSTRUCTION PROCESS SHALL BE AS OUTLINED ON THE EROSION AND SEDIMENT CONTROL PLANS, DETAILS AND NOTES.

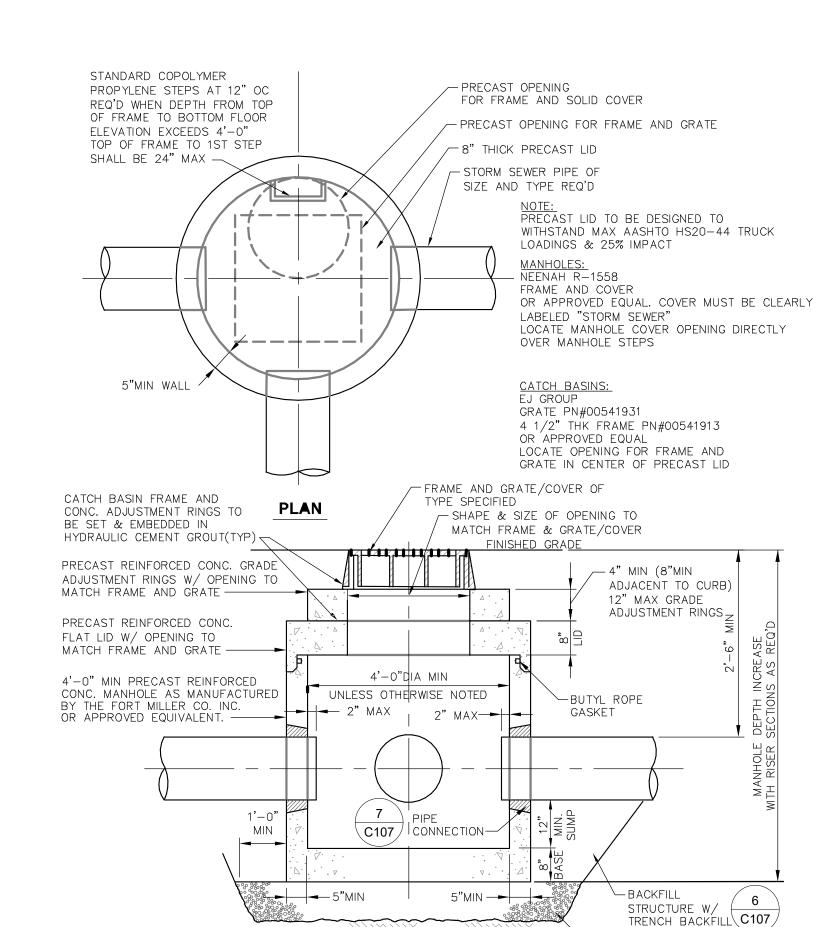

I. CATCH BASIN SHALL BE PRECAST CONCRETE. DESIGNED FOR HS20-44 VEHICULAR LOADING AND

2. FRAME AND COVER SHALL BE DESIGNED FOR HS20-44 VEHICULAR LOADING & 25% IMPACT.

25% IMPACT.

OPENING DIMENSION.

3. CONCRETE CATCH BASIN LID CLEAR OPENING

DIMENSION MUST MATCH FRAME AND GRATE CLEAR

CRUSHED STONE BEDDING ALL PRECAST CONSTRUCTION IN ACCORDANCE W/ASTM C478

FROM FINISHED SURFACE TO THE FLOOR OF THE CONCRETE BASE SHALL BE PROVIDED WITH STEPS. 5. BACKFILL USING TRENCH BACKFILL, COMPACTED IN 6"

4. CATCH BASINS HAVING A DEPTH GREATER THAN 48"

-6" NYSDOT NO 2

6. SUMPS FOR CATCH BASINS SHALL BE 12".


7. ECCENTRIC CONE TOP CAN BE USED FOR MANHOLES DEPTH GREATER THAT 7 FEET.

8. SEE CHART FOR REQUIRED MANHOLES / CATCH BASINS



PRECAST CONCRETE MANHOLE/CB PRECAST CONCRETE MANHOLE SECTION (TYP) BUTYL ROPE AS PRIMARY JOINT SEALER (SEE TABLE BELOW) - EXTEND WALL STEEL REINFORCEMENT INTO JOINT LIPS MANHOLE SIZE OF BUTYL ROPI INSIDE DIAMETER JOINT SEALER 5'-0" & LARGER 1 1/2"

MANHOLE JOINT N.T.S.

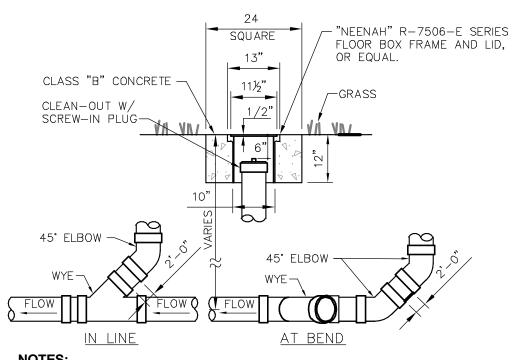

. SEWER PIPE FITTINGS TO BE ASTM D-3033 OR D-3034 2. TO BE USED FOR GRAVITY PORTION OF SANITARY SYSTEM AS WELL AS THE STORM ROOF DRAINAGE SYSTEM.

N.T.S.

Revisions

-Site Plan Review Set-NOT FOR CONSTRUCTION

<u>A</u>ngerame

Architecture

Interior Design

Planning

30 Essex St.

New York 12206

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W angeramearchitects.com

GLEN EDDY -

ADDITIONS

One Ascot Lane

Consultants

Structural:

C 107

C107

Engineered Solutions

MRH Engineering, P.C.

Phone: (518) 280-2410

Niskyuna, NY 12309

Site Plan Review Set

646 Plank Rd. #104 Clifton Park, NY 12065

20 Bayberry Drive, Queensbury, NY 12804

Ph: (518) 792-4042 Cell: (518) 796-6054

Mechanical/Plumbing/Electric Engineer:

THE TERRACE AT

PORTE COCHERE

& DINING ROOM

Albany

Project

Architects, P.C.

SITE DETAILS

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Drawing Number

C107

Date: May 03, 2022

LIGHT TYPE SL-5

TYPE 'B' LIGHT POLE BASE DETAIL

N.T.S.

C 107

C 107

CLEAN OUT - NON TRAFFIC AREA

10 C107

N.T.S.


N.T.S.

2' TYP.

N.T.S.


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N.T.S.

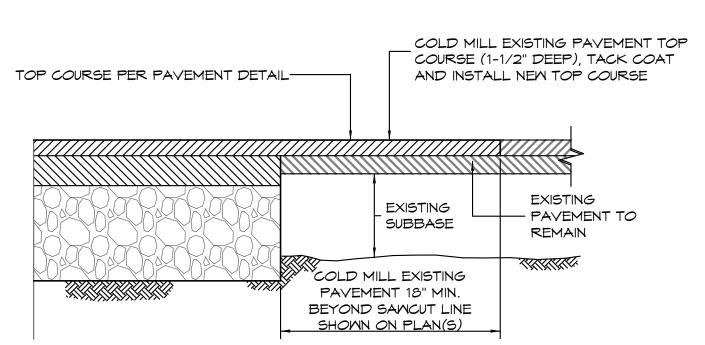

NOTE: 1. REFER TO SPECIFICATIONS FOR DESCRIPTION OF TRENCH MATERIALS, INCLUDING PIPE ZONE BEDDING, BACKFILL, AND SUITABLE

> POST 36" LONG 11/2" x11/2" HARDWOOD SPACING 10' O.C.

> > (SEE NOTE 2)

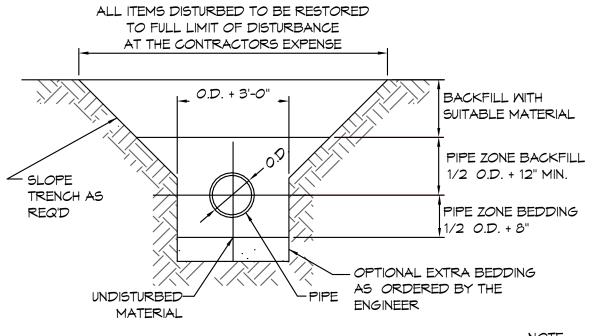36" WIRE FENCING -

STAPLED TO POST

MIRAFI 100X (OR EQUIVALENT) -

MRAP IN TRENCH AS SHOWN

FABRIC (FILTER CLOTH) 30#/IN.

FLOW

14 GA. 6" SQ.

COMPACTED BACKFILL

MATERIAL TYPICAL UTILITY TRENCH DETAIL SCALE: N.T.S.

GEOTEXTILE

ATTACHED TO

MOOD STAKE

FLOW

OR

GRADE

ORIGINAL

GROUND

PROPOSED

AND FRAME

2" x 4"

MOOD

FRAME

DROP INLET

IN GROUND (TYP.)


GEOTEXTILE TO BE BURIED

ELEVATION

2" × 4"

FLOW

STAKE -

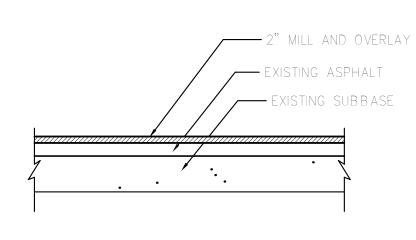






NOTES

SCALE: N.T.S.

- 1. TIE FABRIC TO MIRE FENCE IN ACCORDANCE MITH MANUFACTURERS RECOMMENDATIONS.
- 2. IF EXTRA STRENGTH FABRIC (GREATER THAN 50#/INCH) IS USED, WIRE CAN BE DELETED IF POST SPACING IS REDUCED TO 6'
- 3. AT THE ENDS OF THE FENCING THE FIRST 20' SHALL BE TURNED UP THE SLOPE
- 4. POSTS SHOULD BE INCLINED TOWARD THE DIRECTION FLOW CAME FROM.
- 5. OVERLAP FABRIC A MINIMUM OF 6" AND FOLDED AT JOINTS. ATTACH FILTER FABRIS TO STAKES ALLOWING EXTENSION INTO TRENCH AS SHOWN; SECURE TO STAKES AS NOTED.
- 6. THE MAXIMUM AREA OF RUNOFF PER 100LF. OF FENCE SHALL NOT EXCEED
- 7. MAINTENANCE SHALL BE PERFORMED AS NECESSARY. THE FENCING SHALL BE CHECKED AFTER EVERY STORM TO ENSURE THEIR PROPER
- 8. WHEN FENCE IS NO LONGER NEEDED, THE ACCUMULATED SILT, THE POSTS AND FABRIC SHALL BE REMOVED AND TRENCH BACK FILLED WITH TOPSOIL SEEDED.
- 9. FENCING SHOULD BE PLACED AS SHOWN ON THE DRAWING OR IF NOT SHOWN, 10' BEYOND THE TOE OF THE OF THE SLOPE AND AT A SPACING IN ACCORDANCE WITH THE
- 10. EXCAVATE TRENCH AS PER DETAIL AND SET POSTS AT 10' O.C.
- 11. BACKFILL WITH COMPACTED, EXCAVATED SOIL FROM TRENCH.

SILT FENCE DETAIL

ELEVATION

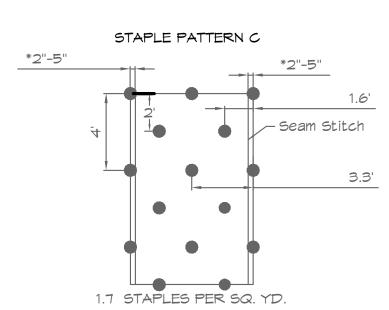

USE FOR S75 & S150 SLOPE PROTECTION MATTING

- 1. PREPARE SOIL BEFORE INSTALLING BLANKETS, INCLUDING ANY NECESSARY APPLICATION OF LIME, FERTILIZER, AND SEED. NOTE: WHEN USING CELL-O-SEED DO NOT SEED PREPARED AREA. CELL-O-SEED MUST BE INSTALLED WITH PAPER SIDE DOWN. 2. BEGIN AT THE TOP OF THE SLOPE BY ANCHORING THE BLANKET IN A 6" (15cm) DEEP X 6" (15cm) WIDE TRENCH WITH APPROXIMATELY 12" (30cm) OF BLANKET EXTENDED BEYOND THE UP-SLOPE PORTION OF THE TRENCH. ANCHOR THE BLANKET WITH A ROW OF STAPLES/STAKES APPROXIMATELY 12" (30cm) APART IN THE BOTTOM OF THE TRENCH. BACKFILL AND COMPACT THE TRENCH AFTER STAPLING. APPLY SEED TO COMPACTED SOIL AND FOLD REMAINING 12" (30cm) PORTION OF BLANKET BACK OVER SEED AND COMPACTED SOIL. SECURE BLANKET OVER COMPACTED SOIL WITH A ROW OF
- 3. ROLL THE BLANKETS (A.) DOWN OR (B.) HORIZONTALLY ACROSS THE SLOPE. BLANKETS WILL UNROLL WITH APPROPRIATE SIDE AGAINST THE SOIL SURFACE. ALL BLANKETS MUST BE SECURELY FASTENED TO SOIL SURFACE BY PLACING STAPLES/STAKES IN APPROPRIATE LOCATIONS AS SHOWN IN THE STAPLE PATTERN GUIDE. WHEN USING OPTIONAL DOT SYSTEM, STAPLES/STAKES SHOULD BE PLACED THROUGH EACH OF THE COLORED DOTS CORRESPONDING TO THE APPROPRIATE STAPLE PATTERN.
- ON BLANKET TYPE. TO ENSURE PROPER SEAM ALIGNMENT, PLACE THE EDGE OF THE OVERLAPPING BLANKET (BLANKET BEING INSTALLED ON TOP) EVEN WITH THE COLORED SEAM STITCH ON THE PREVIOUSLY INSTALLED BLANKET.
- 5. CONSECUTIVE BLANKETS SPLICED DOWN THE SLOPE MUST BE PLACED END OVER END (SHINGLE STYLE) WITH AN APPROXIMATE 3" (7.5cm) OVERLAP. STAPLE THROUGH OVERLAPPED AREA, APPROXIMATELY 12" (30cm) APART ACROSS ENTIRE

*IN LOOSE SOIL CONDITIONS, THE USE OF STAPLE OR STAKE LENGTHS GREATER THAN 6" (15cm) MAY BE NECESSARY TO PROPERLY SECURE THE BLANKETS.

30 Essex St. Albany New York 12206 P 518 454 9300 F 518 454 9333 W angeramearchitects.com Project

THE TERRACE AT GLEN EDDY -PORTE COCHERE & DINING ROOM **ADDITIONS**

<u>A</u>ngerame

Architecture

Interior Design

Planning

Architects, P.C

One Ascot Lane Niskyuna, NY 12309

Site Plan Review Set

Consultants

Mechanical/Plumbing/Electric Engineer: Engineered Solutions 646 Plank Rd. #104 Clifton Park, NY 12065 Phone: (518) 280-2410

Structural:

MRH Engineering, P.C. 20 Bayberry Drive, Queensbury, NY 12804 Ph: (518) 792-4042 Cell: (518) 796-6054

-Site Plan Review Set-NOT FOR CONSTRUCTION

SITE DETAILS

express written consent of Angerame Architects, P. C.

Drawing Number

C108

Date: **May 03, 2022**

NOT USED SCALE: N.T.S.

NOT USED

FLOW

FRAME.

N.T.S.

SEE NOTE 3

OVERLAPPED TO THE NEXT STAKE.

5. GEOTEXTILE FABRIC SHALL HAVE EOS OF 40-85.

7. INLET PROTECTION TO REMAIN IN-PLACE UNTIL AREA IS STABILIZED.

- 2" × 4"

MOOD

FRAME

STAKE (TYP.)

DROP INLET

GEOTEXTILE ATTACHED

2. STAKE MATERIAL WILL BE STANDARD 2"X4" WOOD OR EQUIVALENT METAL WITH A MINIMUM LENGTH OF 3 FEET.

1. GEOTEXTILE SHALL BE CUT FROM A CONTINUOUS ROLL TO ELIMINATE JOINTS. IF JOINTS ARE NECESSARY THEY WILL BE

3. SPACE STAKES EVENLY AROUND INLET WITH A MAXIMUM SPACING OF 3 FEET DRIVE STAKES 18" MINIMUM INTO GROUND.

4. GEOTEXTILE SHALL BE EMBEDDED 12" BELOW GROUND AND BACKFILLED. IT SHALL BE SECURELY FASTENED TO STAKES

TO WOOD FRAME

FLOW

WIRE MESH MAY BE REQUIRED BEHIND GEOTEXTILE TO PROVIDE SUPPORT.

FILTER FABRIC DROP INLET PROTECTION DETAIL

6. A 2"X 4" WOOD FRAME SHALL BE FORMED AROUND THE CREST OF FABRIC FOR OVERFLOW STABILITY.


N.T.S.

STAPLES/STAKES SPACED APPROXIMATELY 12" (30cm) APART ACROSS THE WIDTH OF THE BLANKET.

4. THE EDGES OF PARALLEL BLANKETS MUST BE STAPLED WITH APPROXIMATELY 2"-5" (5cm-12.5cm) OVERLAP DEPENDING

BLANKET MIDTH.

EROSION CONTROL BLANKET DETAIL

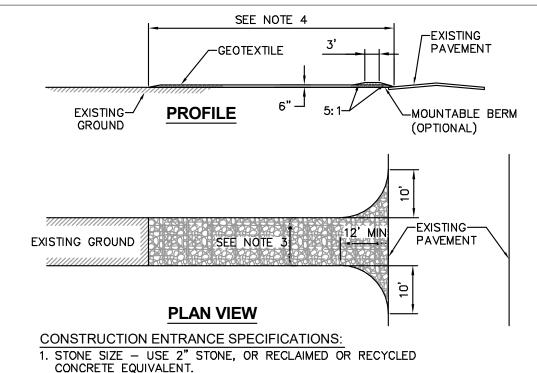


- 2. THICKNESS NOT LESS THAN SIX (6) INCHES. 3. WIDTH — TWELVE (12) FOOT MINIMUM, BUT NOT LESS THAN THE FULL WIDTH AT POINTS WHERE INGRESS OR EGRESS OCCURS.
- TWENTY FOUR (24) FEET IF SINGLE ENTRANCE TO SITE. 4. LENGTH - NOT LESS THAN 50' (EXCEPT ON A SINGLE RESIDENCE
- LOT WHERE A 30' MINIMUM LENGTH WOULD APPLY). 5. GEOTEXTILE - WILL BE PLACED OVER THE ENTIRE AREA PRIOR TO PLACING OF STONE
- 6. SURFACE WATER ALL SURFACE WATER FLOWING OR DIVERTED TOWARD CONSTRUCTION ENTRANCES SHALL BE PIPED ACROSS THE ENTRANCE. IF PIPING IS IMPRACTICAL, A MOUNTABLE BERM WITH
- 5:1 SLOPES WILL BE PERMITTED.
 7. MAINTENANCE THE ENTRANCE SHALL BE MAINTAINED IN A CONDITION WHICH WILL PREVENT TRACKING OR FLOWING OF SEDIMENT ONTO PUBLIC RIGHTS-OF-WAY. THIS MAY REQUIRE PERIODIC TOP DRESSING WITH ADDITIONAL STONE AS CONDITIONS DEMAND AND REPAIR AND/OR CLEANOUT OF ANY MEASURES USED TO TRAP SEDIMENT. ALL SEDIMENT SPILLED, DROPPED, WASHED OR TRACKED ONTO PUBLIC RIGHTS-OF-WAY MUST BE
- REMOVED IMMEDIATELY. 8. WASHING - WHEELS SHALL BE CLEANED TO REMOVE SEDIMENT PRIOR TO ENTRANCE ONTO PUBLIC RIGHTS-OF-WAY. WHEN WASHING IS REQUIRED, IT SHALL BE DONE ON AN AREA STABILIZED WITH STONE AND WHICH DRAINS INTO AN APPROVED
- 9. PERIODIC INSPECTION AND NEEDED MAINTENANCE SHALL BE PROVIDED AFTER EACH RAIN.

SEDIMENT TRAPPING DEVICE.

STABILIZED CONSTRUCTION ENTRANCE

SCALE: N.T.S.

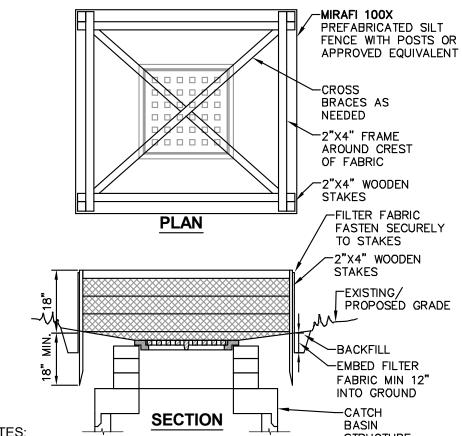

STRUCTURE FILTER FABRIC SHALL HAVE AN EOS OF 40-85. 2. CUT FABRIC FROM CONTINUOUS ROLL TO ELIMINATE JOINTS. IF JOINTS ARE NEEDED, OVERLAP TO THE NEXT STAKE.


3. STAKE MATERIALS WILL BE STANDARD 2"x4" WOOD OR EQUIVALENT, WITH A

- MINIMUM LENGTH OF 3 FEET. 4. SPACE STAKES EVENLY AROUND INLET 3 FEET APART AND DRIVE MINIMUM 18"
- DEEP. SPANS GREATER THAN 3 FEET MAY BE BRIDGED WITH THE USE OF WIRE MESH BEHIND FABRIC FOR SUPPORT.
- 5. FABRIC SHALL BE EMBEDDED 1 FOOT MINIMUM BELOW GROUND AND BACKFILLED. IT SHALL BE SECURELY FASTENED TO THE STAKES AND FRAME.
- 6. A 2"x4" WOOD FRAME SHALL BE COMPLETED AROUND THE CREST OF THE FABRIC FOR OVERFLOW STABILITY. 7. MAXIMUM DRAINAGE AREA IS 1 ACRE.
- 8. INLET PROTECTION SHALL REMAIN IN-PLACE UNTIL SITE HAS BEEN STABILIZED.

TEMPORARY INLET PROTECTION

SCALE: N.T.S.

STONE APRON SIZING REQUIREMENT - TABLE "A"						
CULVERT DIA. (D)	CULVERT SLOPE, %	NYSDOT STANDARD STONE FILLING APRON MATERIAL	d50	dMAX	MINIMUM APRON THICKNESS (IN)	MINIMUM OUTLET APRON LENGTH(FT) (La)
12"	< 8	LIGHT	6"	9"	18	10
	8–10	MEDIUM	9"-12"	14"-18"	24	10
18"	< 4	LIGHT	6"	9"	18	10
	4-6	MEDIUM	9"-12"	14"–18"	24	12
	6-8	HEAVY	15"–18"	22"-27"	36	12
	8-10	HEAVY	15"-18"	22"-27"	36	18

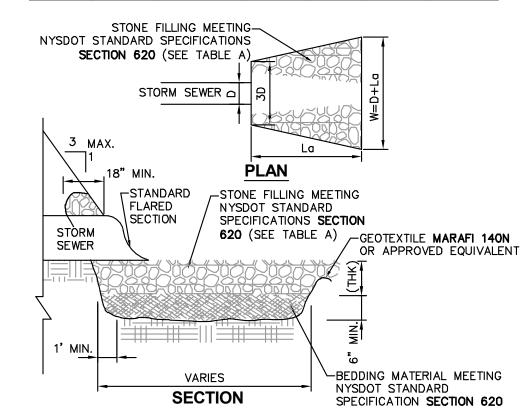

TEMPORARY CONCRETE WASHOUT

REPLACEMENT OF THE 10 MIL POLYETHLENE

SCALE: N.T.S.

-WOVEN WIRE FENCE (MIN. 14 10'MAX CENTER TO CENTER GAUGE W/ MAX. 6" MESH SPACIN 36" MIN FENCE POSTS, DRIVEN MIN 16" INTO GROUND PERSPECTIVE VIEW MIRAFI 100X PREFABRICATED— SILT FENCE WITH POSTS OR ·36" MIN FENCE POST APPROVED EQUIVALENT -UNDISTURBED GROUND EMBED FILTER FABRIC MIN 6" INTO GROUND -TAMPED EXCAVATED-

BACKFILL 1. WOVEN WIRE FENCE TO BE FASTENED SECURELY TO FENCE POSTS WITH WIRE TIES OR STAPLES. POSTS SHALL BE STEEL "T" OR "U" TYPE OR HARDWOOD. 2. FILTER FABRIC TO BE FASTENED SECURELY TO WOVEN WIRE FENCE WITH TIES SPACED EVERY 24" AT TOP AND MID SECTION. FENCE SHALL BE WOVEN WIRE, 6"

3. WHEN TWO SECTIONS OF FILTER FABRIC ADJOIN EACH OTHER THEY SHALL BE OVERLAPPED BY 6" AND FOLDED. 4. MAINTENANCE SHALL BE PERFORMED AS NEEDED AND MATERIALS REMOVED WHEN "BULGES" DEVELOP IN THE SILT FENCE. 5. MAXIMUM DRAINAGE AREA FOR OVERLAND FLOW TO A SILT FENCE SHALL NOT

EXCEED 1/4 ACRE PER 100 FEET OF FENCE. 6. SILT FENCE SHALL BE USED WHERE EROSION COULD OCCUR IN THE FORM OF

7. SILT FENCE SHALL NOT BE USED WHEN A CONCENTRATION OF WATER IS FLOWING TO THE BARRIER. 8. MAXIMUM ALLOWABLE SLOPE LENGTHS CONTRIBUTING RUN-OFF TO A SILT FENCE ARE: SLOPE STEEPNESS MAXIMUM SLOPE LENGTH(FT)




SILT FENCE

SCALE: N.T.S.

A109

A109

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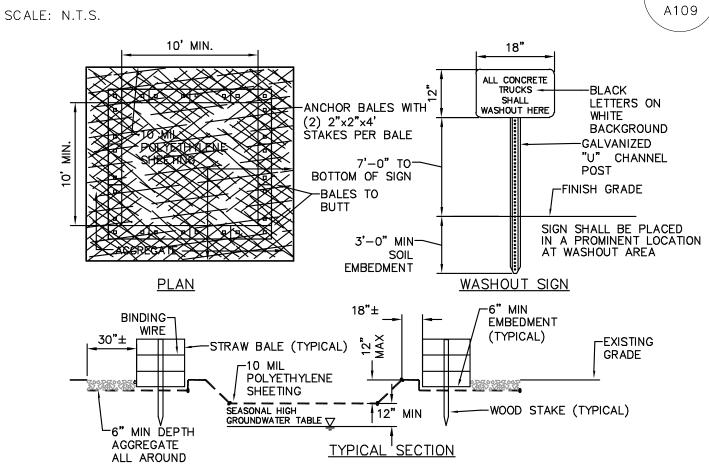


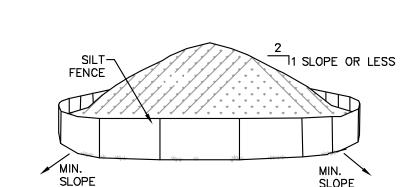1. AREA CHOSEN FOR STOCKPILING OPERATIONS SHALL BE DRY AND STABLE. 2. MAXIMUM SLOPE OF STOCKPILE SHALL BE 1V: 2H.
3. UPON COMPLETION OF SOIL STOCKPILING, EACH PILE SHALL

BE SURROUNDED WITH SILT FENCING, THEN STABILIZED WITH VEGETATION OR COVERED.

4. SEE SPECIFICATIONS FOR INSTALLATION OF SILT FENCE.

TEMPORARY SOIL STOCKPILE



4. WASHOUT AREA(S) SHALL BE INSTALLED IN A CONTAINMENT MUST BE STRUCTURALLY SOUND AND LEAK FREE AND CONTAIN ALL LIQUID LOCATION EASILY ACCESSIBLE BY CONCRETE TRUCKS.

2. CONTAINMENT DEVICES MUST BE OF SUFFICIENT THE CONSTRUCTION SITE AND MAY BE QUANTITY OR VOLUME TO COMPLETELY CONTAIN THE LIQUID WASTES GENERATED. 3. WASHOUT MUST BE CLEANED OR NEW FACILITIES CONSTRUCTED AND READY TO USE

RELOCATED AS CONSTRUCTION PROGRESSES. 6. AT LEAST WEEKLY, REMOVE ACCUMULATION OF SAND AND AGGREGATE AND DISPOSE OF PROPERLY. ONCE WASHOUT IS 75% FULL. THIS INCLUDES

. ONE OR MORE AREAS MAY BE INSTALLED ON

FLEXSTORM INLET PROTECTION A109

A109

SPDES GENERAL PERMIT GP-0-15-002 COMPLIANCE NOTES:

THIS PLAN SET AND THE ACCOMPANYING SWPPP "ENTITLED" ALBANY COUNTY RESIDENTIAL HEALTH CARE FACILITY RENOVATION HAVE BEEN SUBMITTED AS A SET. THESE ENGINEERING DRAWINGS ARE CONSIDERED AN INTEGRAL PART OF THE SWPPP, THEREFORE THE PLAN SET IS NOT CONSIDERED COMPLETE WITHOUT THE

1. THIS PROJECT HAS NOT RECEIVED WRITTEN APPROVAL FROM NYSDEC ALLOWING THE DISTURBANCE OF MORE THAN FIVE (5) ACRES OF LAND AT ANY ONE TIME. THEREFORE, IF THE CONTRACTOR'S CONSTRUCTION SEQUENCE REQUIRES THE DISTURBANCE OF MORE THAN FIVE ACRES AT ANY ONE TIME, WRITTEN APPROVAL MUST BE OBTAINED FROM NYSDEC PRIOR TO EXCEEDING THE 5 ACRE

CONSTRUCTION SEQUENCING NOTES:

- PRIOR TO COMMENCING ANY CLEARING, GRUBBING, EARTHWORK ACTIVITIES, ETC.AT THE SITE, THE CONTRACTOR SHALL FLAG THE WORK LIMITS AND SHALL INSTALL TEMPORARY EROSION AND SEDIMENT CONTROL MEASURES (I.E. SILT FENCES, TREE PROTECTION/BARRIER FENCES, STABILIZED CONSTRUCTION ENTRANCES, STORM DRAIN SEDIMENT FILTERS, DRAINAGE DITCH SEDIMENT FILTERS, ETC.) INDICATED ON THE PROJECT DRAWINGS. TEMPORARY EROSION AND SEDIMENT CONTROL MEASURES MUST BE CONSTRUCTED, STABILIZED, AND
- FUNCTIONAL BEFORE SITE DISTURBANCE BEGINS WITHIN THEIR TRIBUTARY AREAS. 2. THE STORMWATER INFILTRATION BASIN SHALL NOT BE UTILIZED AS A TEMPORARY SEDIMENT TRAP DURING CONSTRUCTION.
- CLEARING & GRADING OF THE PROPOSED AREA OF DISTURBANCE AS REQUIRED. 4. INSTALL PROTECTIVE MEASURES AT THE LOCATIONS OF ALL GRATE INLETS, CURB INLETS, AND AT THE ENDS OF ALL EXPOSED STORM SEWER PIPES.

3. THE CONTRACTOR SHALL COMMENCE SITE CONSTRUCTION ACTIVITIES INCLUDING

- 5. CONSTRUCT ALL UTILITIES, AREA INLETS, AND STORM SEWER SYSTEM, AS SHOWN ON THE PLANS. INLET PROTECTION MAY BE REMOVED TEMPORARILY FOR THIS CONSTRUCTION. PLACE REQUIRED RIP—RAP AT LOCATIONS SHOWN ON THE
- 6. FINALIZE PAVEMENT SUB-GRADE PREPARATION.

SILT AND SEDIMENT.

- INSTALL SUB-BASE MATERIAL AS REQUIRED FOR PAVEMENT. 8. PRIOR TO FINALIZING CONSTRUCTION OF THE STORMWATER MANAGEMENT FACILITY, ALL CATCH BASINS AND DRAINAGE LINES SHALL BE CLEANED OF ALL
- 9. THE CONTRACTOR SHALL REMOVE ALL TEMPORARY EROSION AND SEDIMENT CONTROL MEASURES AND IMMEDIATELY ESTABLISH PERMANENT VEGETATION ON THE AREAS DISTURBED DURING THEIR REMOVAL.

EROSION AND SEDIMENT CONTROL MEASURES:

- DAMAGE TO SURFACE WATERS RESULTING FROM EROSION AND SEDIMENTATION SHALL BE MINIMIZED BY STABILIZING DISTURBED AREAS AND BY REMOVING SEDIMENT FROM CONSTRUCTION SITE DISCHARGES. 2. AS MUCH AS IS PRACTICAL, EXISTING VEGETATION SHALL BE PRESERVED. FOLLOWING THE COMPLETION OF CONSTRUCTION ACTIVITIES IN ANY PORTION OF
- THE SITE, PERMANENT VEGETATION SHALL BE ESTABLISHED ON ALL EXPOSED SOILS. 3. SITE PREPARATION ACTIVITIES SHALL BE PLANNED TO MINIMIZE THE SCOPE AND
- DURATION OF SOIL DISRUPTION. 4. PERMANENT TRAFFIC CORRIDORS SHALL BE ESTABLISHED AND "ROUTES OF CONVENIENCE" SHALL BE AVOIDED. STABILIZED CONSTRUCTION ENTRANCES SHALL

GENERAL EROSION AND SEDIMENT CONTROL NOTES

BE INSTALLED AT ALL POINTS OF ENTRY ONTO THE PROJECT SITE.

ALL EROSION AND SEDIMENT CONTROL MEASURES ARE TO BE IN STRICT COMPLIANCE WITH "NEW YORK STATE STANDARDS AND SPECIFICATIONS FOR EROSION AND SEDIMENT CONTROL", JULY 2016.

- 2. EXCESS SOIL TO BE STOCKPILED WITHIN THE LIMITS OF SITE DISTURBANCE IF NOT USED IMMEDIATELY FOR GRADING PURPOSES. INSTALL SILT FENCE AROUND SOIL
- 3. APPLY SURFACE STABILIZATION AND RESTORATION MEASURES. AREAS UNDERGOING CLEARING OR GRADING AND ANY AREAS DISTURBED BY CONSTRUCTION ACTIVITIES WHERE WORK IS DELAYED, SUSPENDED, OR INCOMPLETE AND WILL NOT BE REDISTURBED FOR 21 DAYS OR MORE SHALL BE STABILIZED WITH TEMPORARY VEGETATIVE COVER WITHIN 14 DAYS AFTER CONSTRUCTION ACTIVITY IN THAT PORTION OF THE SITE HAS CEASED. (SEE SPECIFICATIONS FOR TEMPORARY VEGETATIVE COVER), AREAS UNDERGOING CLEARING OR GRADING AND ANY AREAS DISTURBED BY CONSTRUCTION ACTIVITIES WHERE WORK IS COMPLETE AND WILL NOT BE REDISTURBED SHALL BE STABILIZED AND RESTORED WITH PERMANENT VEGETATIVE COVER AS SOON AS SITE AREAS ARE AVAILABLE AND WITHIN 14 DAYS AFTER WORK IS COMPLETE. (SEE SPECIFICATIONS FOR PERMANENT VEGETATIVE COVER). SEEDING FOR PERMANENT VEGETATIVE COVER SHALL BE WITHIN THE SEASONAL LIMITATIONS. PROVIDE STABILIZATION WITH TEMPORARY VEGETATIVE COVER WITHIN 14 DAYS AFTER WORK IS COMPLETE, FOR SEEDING OUTSIDE PERMITTED SEEDING PERIODS.
- 4. SEEDED AREAS TO BE MULCHED WITH STRAW OR HAY MULCH IN ACCORDANCE WITH VEGETATIVE COVER SPECIFICATIONS.
- 5. THE CONTRACTOR IS RESPONSIBLE FOR THE INSTALLATION AND MAINTENANCE OF ALL EROSION AND SEDIMENT CONTROL MEASURES THROUGHOUT THE COURSE OF CONSTRUCTION.
- 6. THE CONTRACTOR IS RESPONSIBLE FOR CONTROLLING DUST BY SPRINKLING EXPOSED SOIL AREAS PERIODICALLY WITH WATER AS REQUIRED. THE CONTRACTOR IS TO SUPPLY ALL EQUIPMENT AND WATER. 7. WHEN ALL DISTURBED AREAS ARE STABLE, ALL TEMPORARY EROSION AND SEDIMENT
- CONTROL MEASURES SHALL BE REMOVED. B. CONTRACTOR TO INSPECT FOR CONSTRUCTION DEBRIS IN PUBLIC AREAS DAILY, AND O POWER SWEEP HERITAGE ROAD AND DESIGNATED TEMPORARY PARKING AREAS

INSTALLATION:

1. REMOVE GRATE

3. REPLACE GRATE

2. DROP FLEXSTORM INLET FILTER

ONTO LOAD BEARING LIP OF

CASTING OR CONCRETE STRUCTURE

A109

MAINTENANCE OF EROSION AND SEDIMENT CONTROL MEASURES: PERMANENT AND TEMPORARY VEGETATION: INSPECT ALL AREAS THAT HAVE RECEIVED VEGETATION EVERY SEVEN DAYS & AFTER EVERY RAIN EVENT. ALL AREAS DAMAGED BY EROSION OR WHERE SEED HAS NOT

ESTABLISHED SHALL BE REPAIRED AND RESTABILIZED IMMEDIATELY.

STABILIZED CONSTRUCTION ENTRANCE:
INSPECT THE ENTRANCE PAD EVERY SEVEN DAYS & AFTER EVERY RAIN EVENT. CHECK FOR MUD. SEDIMENT BUILD-UP AND PAD INTEGRITY. MAKE DAILY INSPECTIONS DURING WET WEATHER. RESHAPE PAD AS NEEDED FOR DRAINAGE AND RUNOFF CONTROL. WASH AND REPLACE STONE AS NEEDED. THE STONE IN THE ENTRANCE SHOULD BE WASHED OR REPLACED WHENEVER THE ENTRANCE FAILS TO REDUCE MUD BEING CARRIED OFF-SITE BY VEHICLES. IMMEDIATELY REMOVE MUD AND SEDIMENT TRACKED OR WASHED ONTO PUBLIC ROADS BY BRUSHING OR SWEEPING. REMOVE TEMPORARY CONSTRUCTION

ENTRANCE AS SOON AS THEY ARE NO LONGER NEEDED TO PROVIDE ACCESS TO THE

SILT FENCE:
INSPECT FOR DAMAGE EVERY SEVEN DAYS & AFTER EVERY RAIN EVENT. MAKE ALL REPAIRS IMMEDIATELY. REMOVE SEDIMENT FROM THE UP-SLOPE FACE OF THE FENCE BEFORE IT ACCUMULATES TO A HEIGHT EQUAL TO 1/3 THE HEIGHT OF THE FENCE. I FENCE FABRIC TEARS, BEGINS TO DECOMPOSE, OR IN ANY WAY BECOMES INEFFECTIVE, REPLACE THE AFFECTED SECTION OF FENCE IMMEDIATELY.

SOIL STOCKPILE:
INSPECT SEDIMENT CONTROL BARRIERS (SILT FENCE OR HAY BALE) AND VEGETATION
FOR DAMAGE EVERY SEVEN DAYS & AFTER EVERY RAIN EVENT. MAKE ALL REPAIRS IMMEDIATELY. REMOVE SEDIMENT FROM THE UP-SLOPE FACE OF THE SEDIMENT CONTROL BARRIER BEFORE IT ACCUMULATES TO A HEIGHT EQUAL TO 1/3 THE HEIGHT OF THE SEDIMENT CONTROL BARRIER. IF SEDIMENT CONTROL BARRIER TEARS, BEGINS TO DECOMPOSE, OR IN ANYWAY BECOMES INEFFECTIVE, REPLACE THE AFFECTED SECTION OF SEDIMENT CONTROL BARRIER IMMEDIATELY. REVEGETATE DISTURBED AREA TO STABILIZE SOIL STOCK PILE. REMOVE THE SEDIMENT CONTROL BARRIER WHEN THE SOIL STOCKPILE HAS BEEN REMOVED.

<u>DUST CONTROL:</u>
SCHEDULE CONSTRUCTION OPERATIONS TO MINIMIZE THE AMOUNT OF DISTURBED AREAS AT ANY ONE TIME DURING THE COURSE OF WORK. APPLY TEMPORARY SOIL STABILIZATION PRACTICES SUCH AS MULCHING, SEEDING, AND SPRAYING (WATER). STRUCTURAL MEASURES (MULCH, SEEDING) SHALL BE INSTALLED IN DISTURBED AREAS BEFORE SIGNIFICANT BLOWING PROBLEMS DEVELOP. WATER SHALL BE SPRAYED AS NEEDED. REPEAT AS NEEDED, BUT AVOID EXCESSIVE SPRAYING, WHICH COULD CREATE RUNOFF AND EROSION PROBLEMS.


STORM DRAIN INLET PROTECTION:
INSPECT ALL STORM DRAIN INLET PROTECTION DEVICES EVERY SEVEN DAYS & AFTER EVERY RAIN EVENT. MAKE REPAIRS AS NEEDED, REMOVE SEDIMENT FROM THE POOL AREA AS NECESSARY.

<u>DEWATERING PITS:</u>
(IF REQUIRED) — INSPECT DAILY DURING OPERATION FOR CLOGGING OR OVERFLOW. CLEAR INLET AND DISCHARGE PIPES OF OBSTRUCTIONS. IF A FILTER MATERIAL BECOMES CLOGGED WITH SEDIMENT, PIT SHALL BE DISMANTLED AND CONSTRUCT NEW PITS AS


SNOW AND ICE CONTROL:
PARKING LOTS, ROADWAYS, AND DRIVEWAYS ADJACENT TO WATER QUALITY FILTERS SHALL NOT BE SANDED DURING SNOW EVENTS DUE TO HIGH POTENTIAL FOR CLOGGING FROM SAND IN SURFACE WATER RUNOFF. USE SALT ONLY FOR SNOW AND ICE

TEMPORARY VEGETATIVE COVER (DURING CONSTRUCTION):

SEED MIX: (APPLY AT RATE OF 3 TO 4 LBS PER 1000 SF) AMOUNT BY: MINIMUM % SPECIES OR VARIETY
ANNUAL RYEGRASS

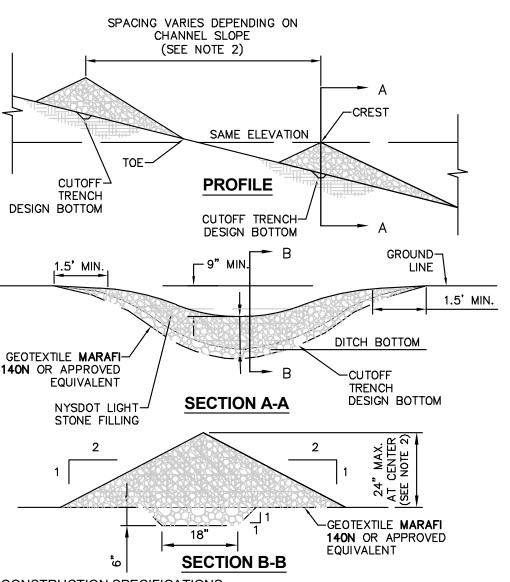

STONE SHALL BE PLACED ON A FILTER FABRIC FOUNDATION TO THE LINES, GRADES AND LOCATIONS SHOWN ON THE PLAN. 2. SET SPACING OF CHECK DAMS IN ACCORDANCE W/ THE FOLLOWING:

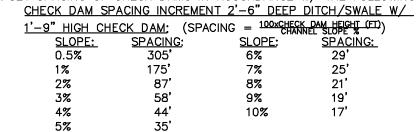

- CONTRACTOR TO ADJUST SPACING ACCORDINGLY BASED ON ACTUAL DEPTH & SLOPE 3. EXTEND THE STONE A MINIMUM OF 1.5 FEET BEYOND THE DITCH BANKS TO PREVENT CUTTING AROUND THE DAM.
- 4. PROTECT THE CHANNEL DOWNSTREAM OF THE LOWEST CHECK DAM FROM SCOUR AND EROSION WITH STONE OR LINER AS APPROPRIATE. 5. ENSURE THAT CHANNEL APPURTENANCES SUCH AS CULVERT ENTRANCES BELOW CHECK DAM ARE NOT SUBJECT TO DAMAGE OR BLOCKAGE FROM

DISPLACED STONE 6. MAXIMUM DRAINAGE AREA IS 2 ACRES.

CHECK DAM DETAIL

SCALE: N.T.S.



Architecture

Interior Design

30 Essex St. Albany New York 12206

Project

THE TERRACE AT GLEN EDDY -PORTE COCHERE & DINING ROOM **ADDITIONS**

One Ascot Lane Niskyuna, NY 12309

Site Plan Review Set

Consultants

Mechanical/Plumbing/Electric Engineer: Engineered Solutions 646 Plank Rd. #104 Clifton Park, NY 12065

Phone: (518) 280-2410 Structural:

MRH Engineering, P.C. 20 Bayberry Drive, Queensbury, NY 12804 Ph: (518) 792-4042 Cell: (518) 796-6054

Revisions

-Site Plan Review Set-NOT FOR CONSTRUCTION

A109

EROSION CONTROL DETAILS & NOTES

All right reserved. No use or reproducti

C109

Date: May 03, 2022

STONE LINED APRON SCALE: N.T.S.

SCALE: N.T.S.

-GALVANIZED STEE

SUSPENSION SYSTEM

HANDLES

-RFPLACEABLE

SEDIMENT BAGS

FILTER FABRIC

-REAR CURB

GUARD FLAP

TIE DOWNS

WITH MAGNETIC

INC. A DIVISION OF ADS, INC. OR EQUIVALENT.

WITH GEOTEXTILE

1. FLEXSTORM CATCH-IT FILTERS FOR TEMPORARY INLET PROTECTION BY INLET & PIPE PROTECTION,

3. CONTRACTOR TO FIELD VERIFY EXISTING STRUCTURE DIMENSIONS PRIOR TO ORDERING FILTERS.

2. ALL FRAMING TO BE CONSTRUCTED OF CORROSION RESISTANT STEEL (ZINC PLATED OR

-STAINLESS

Planning

P 518 454 9300 F 518 454 9333 W angeramearchitects.com

express written consent of Angerame Drawing Number



TOWN OF NISKAYUNA

PLANNING BOARD AND ZONING COMMISSION

AGENDA STATEMENT

AGENDA ITEM NO. VIII. 4	MEETING DATE: 5/9/2022					
TEM TITLE: DISCUSSION: 3333 Consaul Rd. site plan app. for sidewalk improvements ncluding the addition of an ADA ramp.						
PROJECT LEAD: TBD	PROJECT LEAD: TBD					
APPLICANT: Matthew Oates, P.E.						
SUBMITTED BY: Laura Robertson, Town Planner						
REVIEWED BY: ☐ Conservation Advisory Council (CAC) ☐ Zoning Boar ☐ OTHER:	rd of Appeals (ZBA) \square Town Board					
ATTACHMENTS: ☐ Resolution ■ Site Plan ☐ Map ☐ Report ☐ Other:						

SUMMARY STATEMENT:

Matthew Oates, P.E., of Benderson Development, submitted an Application for Site Plan Review for sidewalk and ADA improvements along the existing sidewalk in front of the retail portion of the property at 3333 Consaul Road. The proposed improvements will provide for a wider sidewalk and new ADA access curb ramps.

The property falls within the C-N Neighborhood Commercial zoning district. A search of Town of Niskayuna records revealed 8 businesses located on the property. The business names are included in a document entitled "3333/3337 Consaul Road". A review of Section 220-10 E of the Niskayuna zoning code resulted in the following.

- Permitted principal uses (1) (d) all of the businesses listed in the document are allowable permitted principal uses under the category of neighborhood retail convenience stores with the exception of the Hannaford Food Market.
- Special principal uses (3) (e) the Hannaford Food Market is an acceptable special principal use under the category of food markets.

BACKGROUND INFORMATION

The following documents were included with the Application for Site Plan Review.

 Civil engineering plans (6-pages) entitled "3333-3337 Consaul Rd. Niskayuna, NY 12304 Sidewalk Replacement" by Benderson Development.

- o Pg. 1 Storm Drainage Plan dated 7/28/21 with no subsequent revisions.
- o Pg. 2 Limited topo survey dated 4/14/21 with no revisions
- o Pg. 3 Demolition plan dated 7/28/21 with no revisions
- o Pg. 4 Overall site plan dated 7/28/21 with no revisions
- o Pg. 5 Grading plan dated 7/28/21 with no revisions
- o Pg. 6 Storm drainage plan dated 7/28/21 with no revisions

The project includes the removal of a large portion of the existing concrete sidewalk, removal of a striped portion of existing pavement directly in front of the store that was used for grocery pickups and a removal of a section of existing pavement. A new concrete sidewalk will be installed that is essentially equal to the width of the removed concrete and paved pickup area. Dedicated grocery pickup areas were created in the parking lot. Storm drainage improvements are also included consisting primarily of four long sections of 4" perforated HDPE and 4 cleanouts along the interface of new concrete sidewalk and new paved area. The overall site plan also includes a proposed landscaping plan.

The applicant is appearing before the Planning Board this evening to present the project and answer any questions that arise.

TOWN OF NISKAYUNA

Application for Site Plan Review

Applicant (Owner or Agent):	Location :
$_{Name}$ Benderson Development Company, LLC	Number & Street 3333 - 3337 Consaul Road
Address _ 570 Delaware Avenue	Section-Block-Lot <u>39.00</u> _ <u>5</u> _ <u>2</u>
Buffalo, New York 14202	
Telephone 716-878-9630 Fax	Zoning District
Proposal Description:	
Please see the attached Letter of Intent	

Each site plan application shall be accompanied by:

- 1. Twelve (12) site plan maps prepared by a licensed engineer, architect or surveyor.
 - a. The site plan shall include the following: the title of the drawing, including the name(s), address(es), phone and fax numbers of the applicant and the name address, phone and fax number of the person, firm or organization preparing the map.
 - b. The North point, date and scale.
 - c. Boundaries of the property.
 - d. Existing watercourses and direction of existing and proposed drainage flow.
 - e. The location of all proposed site improvements; proposed water and utility facilities; a description of the method of sewage disposal and location of such facilities; the location of all proposed signs; and location of proposed areas of vegetation.
- 2. A lighting plan showing the lighting distribution of existing or proposed lights, specifications, photometric data, and catalog cuts of the proposed fixture(s) which meet the requirements of Article VIIIB of the Zoning Ordinance of the Town of Niskayuna entitled "Guidelines for Lighting of Outdoor Areas under Site Plan Review".
- 3. Six (6) copies of the short or long Environmental Assessment Form (EAF), as required by 6NYCRR Part 617, "State Environmental Quality Review", and Chapter 95, "Environmental Quality Review", of the Code of the Town of Niskayuna.

- 4. If the application is being made by someone other than the current property owner, the applicant or the agent for the applicant must provide proof that they are authorized to pursue this site plan approval. Such proof may be in the form of a contract for sale or letter by the current owner that the applicant/agent is authorized to proceed with this application.
- 5. Administration Fees: An application for site plan approval shall be submitted to the Planning Board at least ten (10) business days prior to a regular meeting of the Planning Board. Each petition shall be accompanied by a minimum fee of *two hundred dollars* (\$200.00) plus an additional fee based on the square footage of new building construction. Fees are payable to the Town of Niskayuna.
- 6. Consulting Fees: The cost incurred by the Town for the review of an application by the Town Engineer, consulting engineering firm or other consulting fees, in connection with a Board's review of a proposed application shall be charged to the applicant. The Board to whom the application is made shall obtain an estimate from any designated consultant of the amount sufficient to defray the cost of such services and shall collect from the applicant the estimated charges. Any portion of the estimated charges so collected, which are not expended by the Town, shall be returned to the applicant. Any such costs incurred by the Town beyond the estimated charges initially collected from the applicant, shall be collected from the applicant prior to final action upon the application.

Benderson Development Company, LLC			
Signature of applicant: Mallhan Order	Date: 04/26/2022		
Signature of owner (if different from applicant):	MSF Niskayuna, LLC		
Date: 04/26/2022			



BUFFALO, NEW YORK 14202 716.886.0211.P::716.886.1026.F

April 25, 2022

Laura Robertson, AICP - Town Planner Niskayuna Town Hall One Niskayuna Circle Niskayuna, NY 12309

> Re: Niskayuna Square (BPD# 3722)

> > **Proposed Sidewalk Modifications and ADA Improvements**

Dear Ms. Robertson:

At this time, Benderson Development Company, LLC (hereinafter "Benderson") is pleased to be submitting the enclosed site plan application to allow for sidewalk and ADA improvements along the existing sidewalk in front of the retail portion of our Niskayuna Square property. The proposed improvements will provide for a wider sidewalk, new ADA access curb ramps at the southeast end and will match in better to the existing sidewalk in front of Hannaford Supermarket. In support of this application, please find enclosed the following information:

- 1) Civil Engineering Plans prepared by James A. Rumsey, R.A.
- 2) Town of Niskayuna Site Plan Application
- 3) New York State Short Environmental Assessment Form

We believe the proposed improvements will be a significant enhancement to the existing plaza. After review of the enclosed materials, please let us know what the next steps are in the approval process. Should you have any questions or require any additional information, please do not hesitate to contact me by phone at (716) 878-9397 or by e-mail at mattoates@Benderson.com.

Thank you,

BENDERSON DEVELOPMENT COMPANY, LLC

Matthew J. Oates, P.E.

Director, Engineering

RETAIL::OFFICE::INDUSTRIAL::HOTEL::RESIDENTIAL | www.benderson.com

PROPOSED PROJECT


3333-3337 CONSAUL RD
NISKAYUNA, NY 12304
BDC Property # 3722
SITE DEVELOPMENT DRAWINGS

INDEX OF DRAWINGS

DWG.#	DRAWING NAME	REVISION	DATE
C1.0	COVER SHEET		
C2.0	EXISTING SURVEY		
C3.0	DEMOLITION & EROSION CONTROL PLAN AND DETAILS		
C4.0	OVERALL SITE PLAN		
C5.0	GRADING AND UTILITY PLAN		
C5.1	STORM DRAINAGE PLAN		
		,	

OWNER/DEVELOPER:

NAME:	BENDERSON DEVELOPMENT COMPANY, LLC
ADDRESS:	570 DELAWARE AVENUE, BUFFALO, NY 14202
CONTACT:	KATHERINE ROWE
PHONE:	716 - 878 - 9699

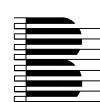

BENDERSON DEVELOPMENT COMPANY, LLC


570 Delaware Ave. Buffalo, New York 14202


SURVEYOR


NAME: GERALD R GRAY- LICENSED LAND SURVEYOR	
ADDRESS:	LATHAM, NY 12110
CONTACT:	GERALD R GRAY
PHONE:	518-312-1335

AGENCIES:

ENGINEERING DEPARTMENT				
NAME/TITLE: MATT YETTO				
COMPANY/DEPT:	TOWN OF NISKAYUNA, NY - ENGINEERING DPT			
ADDRESS:	ONE NISKAYUNA CIRCLE, NISKAYUNA, NY 12309			
PHONE:	518-386-4520			
BUILDING & PLUMB	ING DEPARTMENT			
NAME/TITLE: -				
COMPANY/DEPT: TOWN OF NISKAYUNA, NY - BUILDING DPT				
ADDRESS:	ONE NISKAYUNA CIRCLE, NISKAYUNA, NY 12309			
PHONE: 518-386-4592				
PHONE:	518-386-4592			
PHONE:	518-386-4592			
	7 & UTILITY PERMITS			
NYSDOT - HIGHWAY				
	Y & UTILITY PERMITS			
NYSDOT - HIGHWAY NAME/TITLE:	Y & UTILITY PERMITS PATTI LESTER, SECRETARY			
NYSDOT - HIGHWAY	Y & UTILITY PERMITS PATTI LESTER, SECRETARY NEW YORK STATE DEPARTMENT OF TRANSPORTATION			

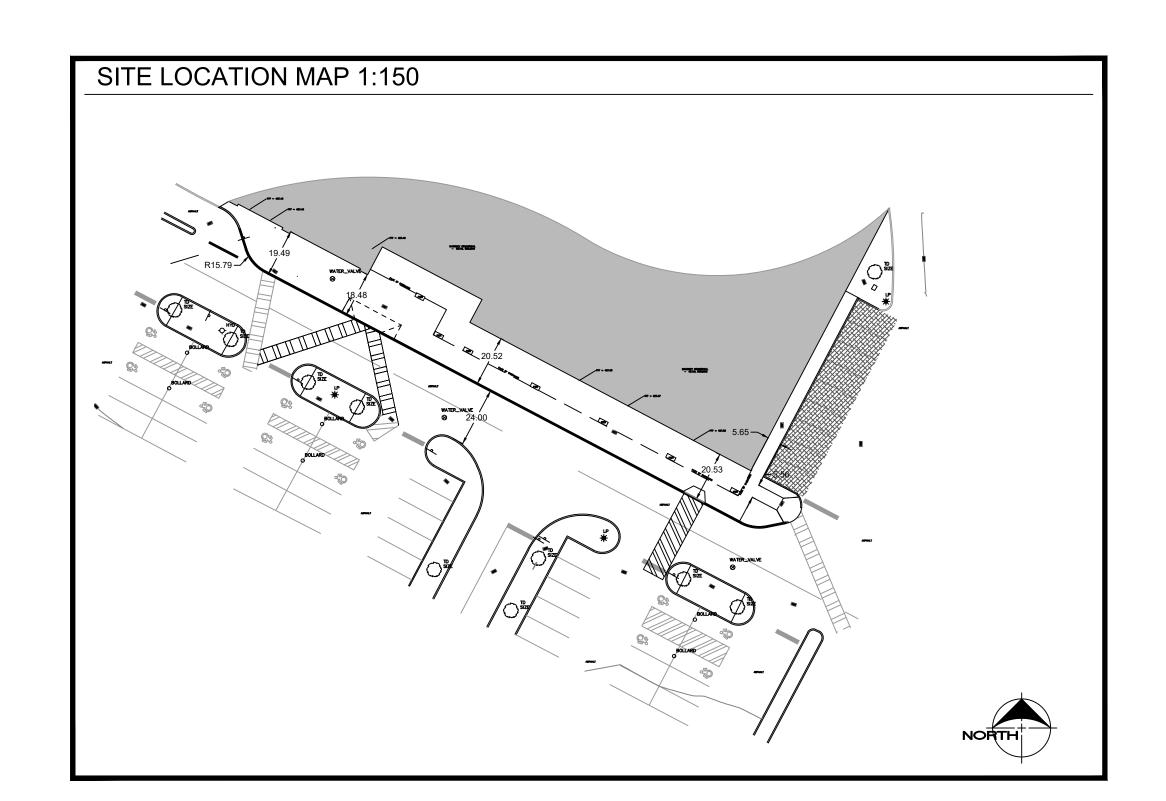

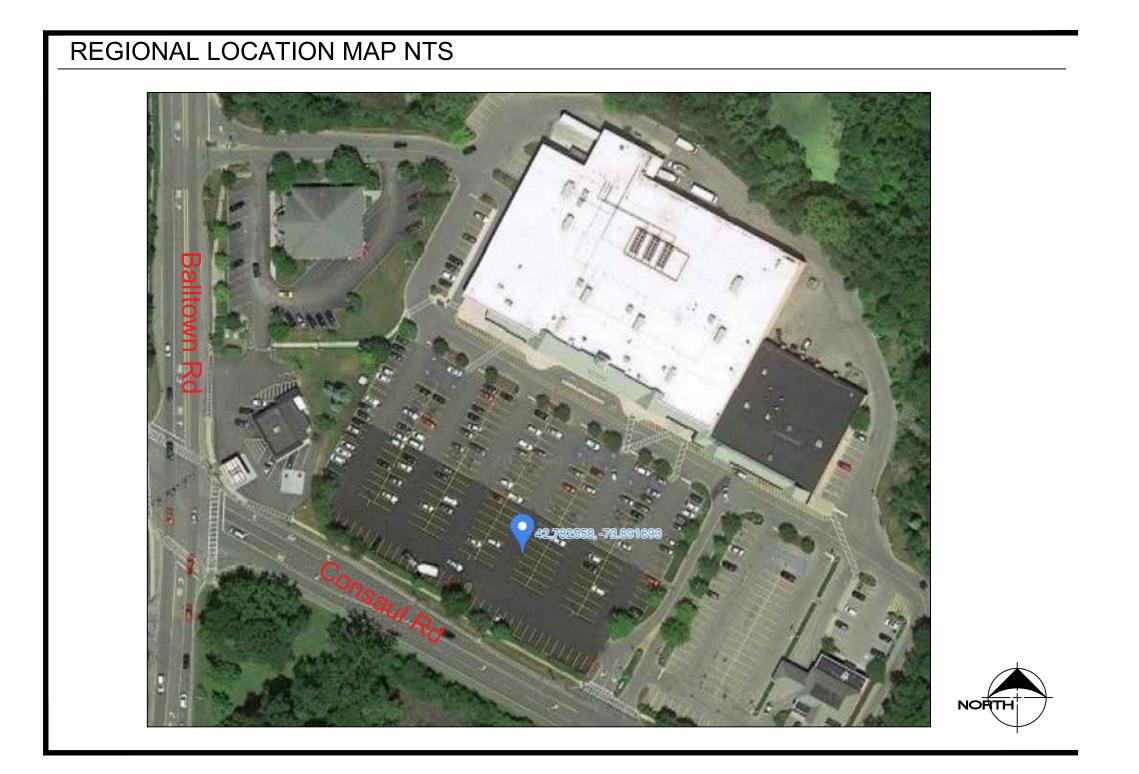

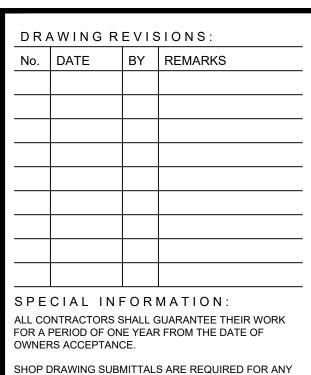

AND ALL STRUCTURES.

IOTICE

UNAUTHORIZED ALTERATIONS OF THIS DOCUMENT ARE IN VIOLATION OF SECTION #7209 OF THE STATE EDUCATION LAW.



PROPERTY NUMBER: # 3722

REPLA

SIDEW,

3-3337 CONSAUL RD SKAYUNA, NY 12304

CONSULTANT

JAMES ALLEN RUMSE
ARCHITECT
PREPARED FOR

DEVELOPMEN 570 DELAWARE AVE., BUFFALO, NY

SEAL


(716) 886-0211





Cover Sheet

CALE: ITS RAWN BY: DRA (ER

C1.

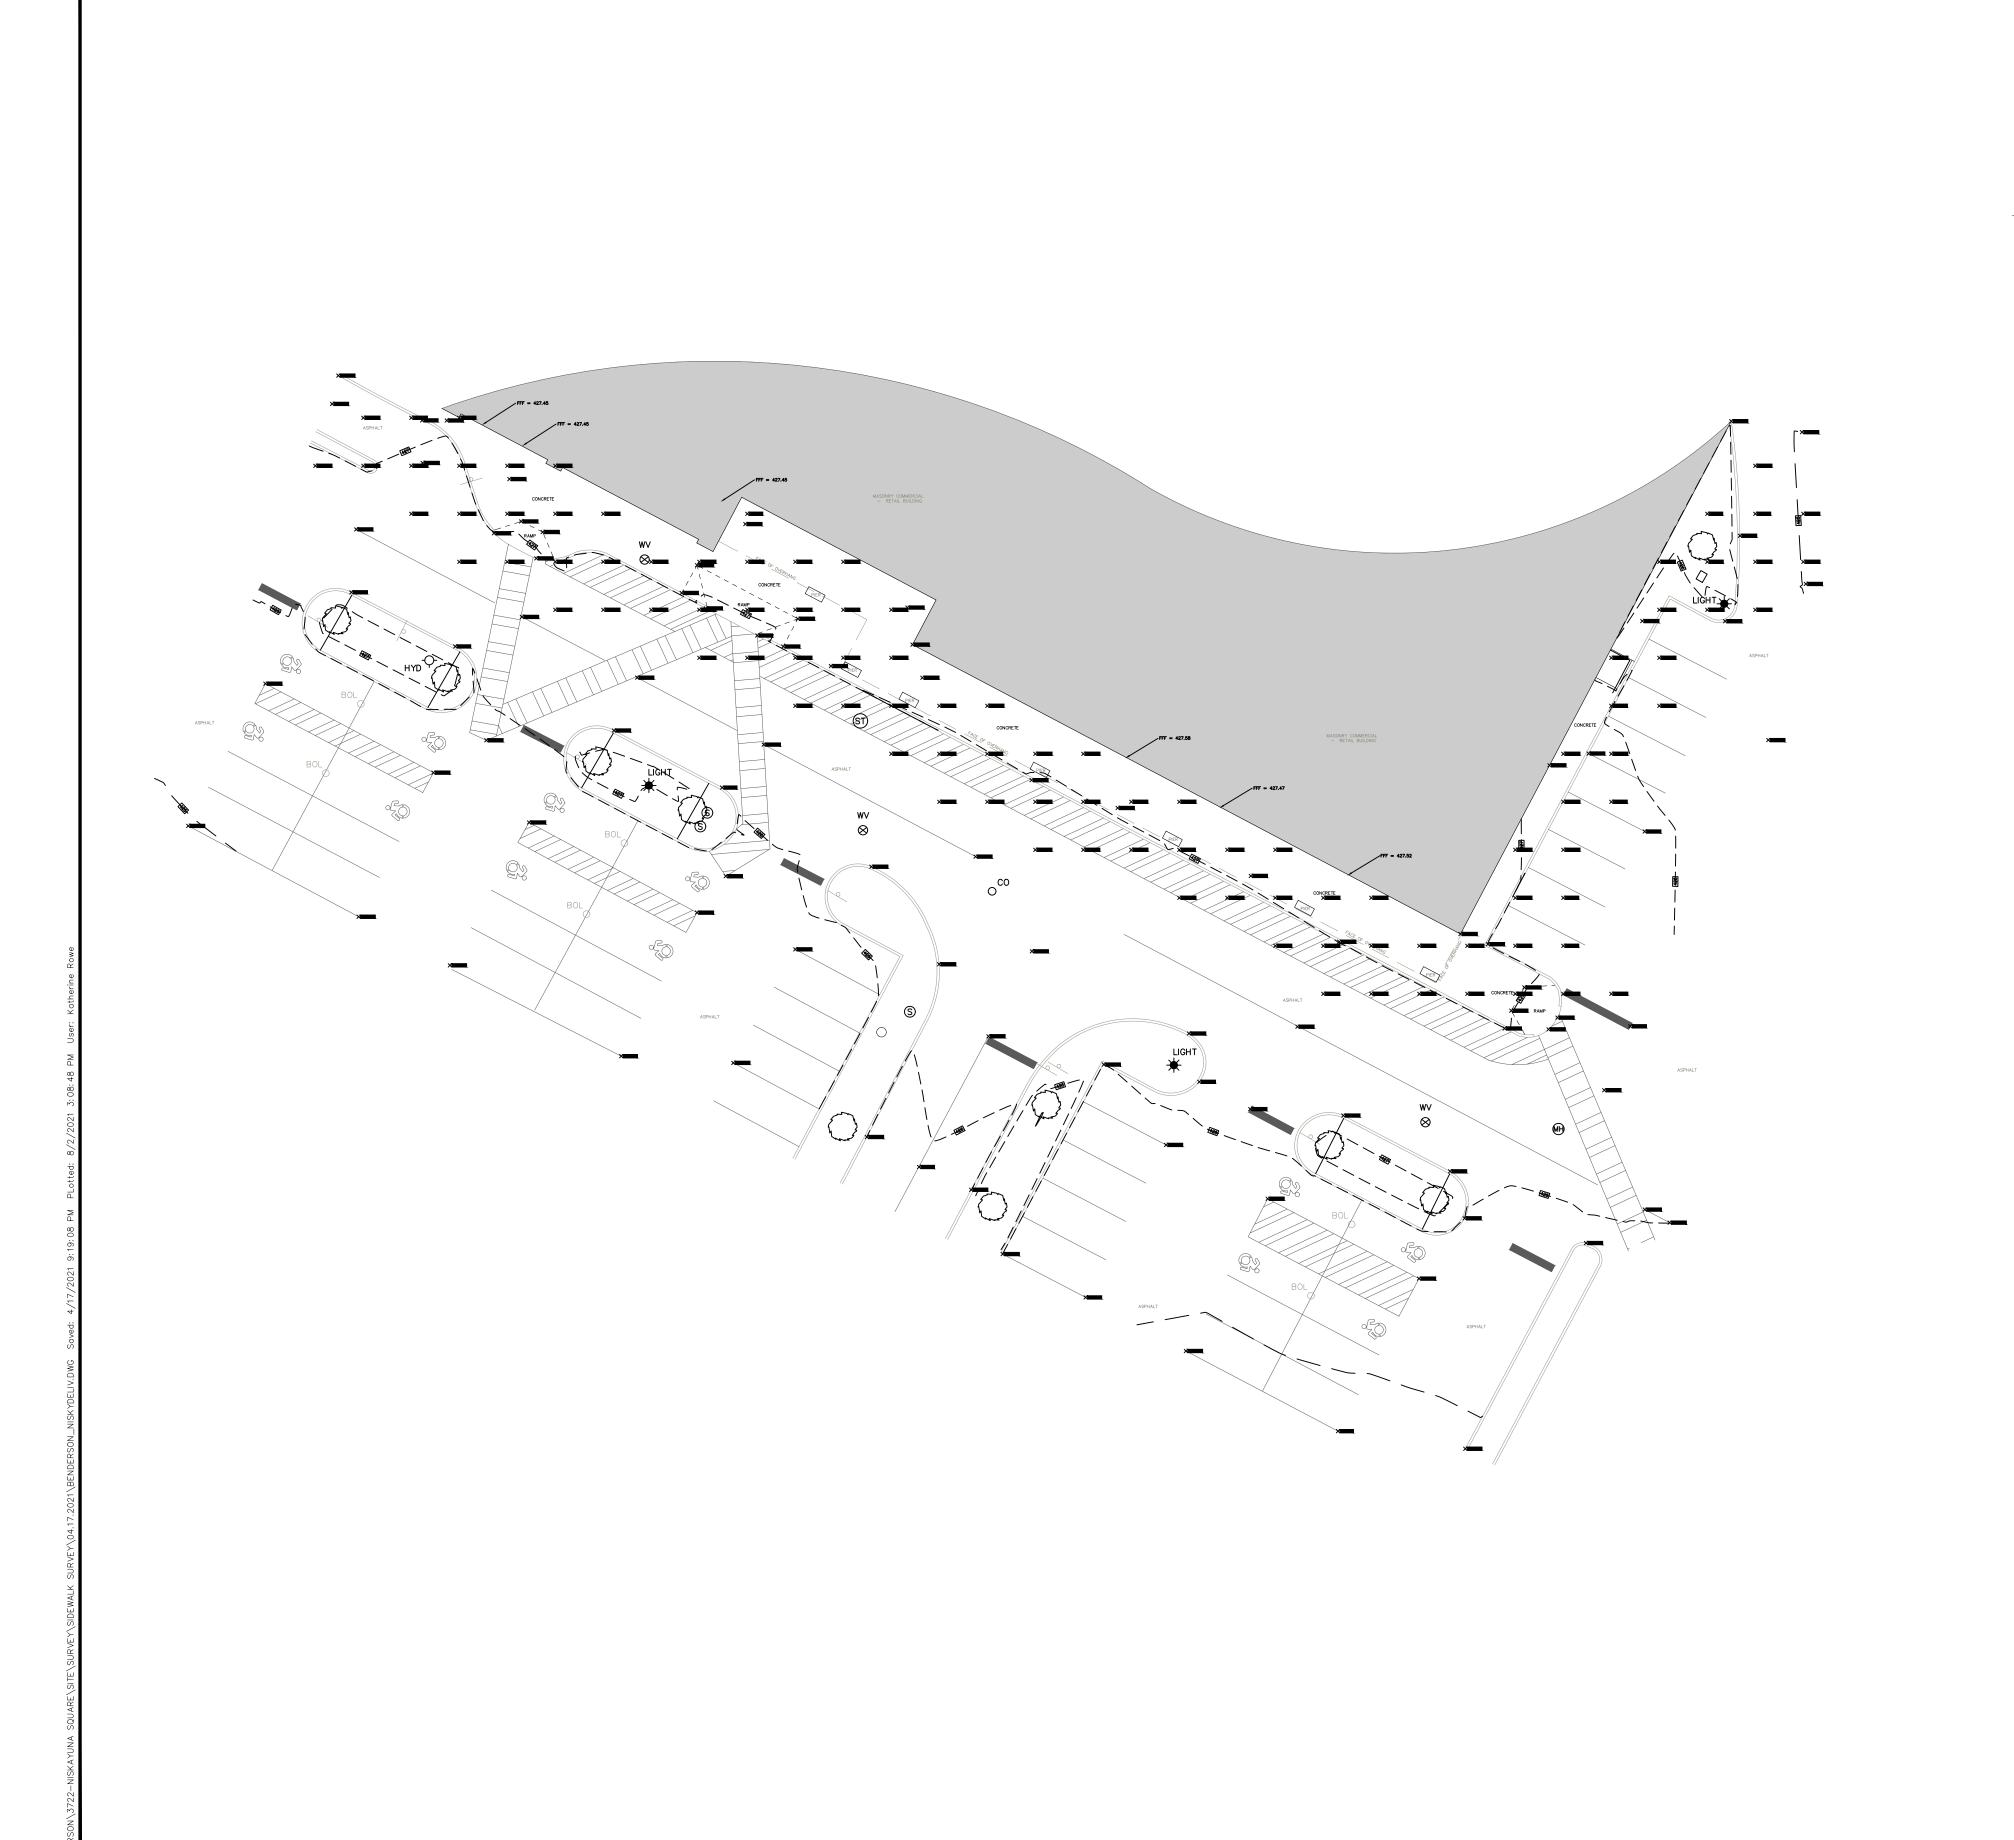

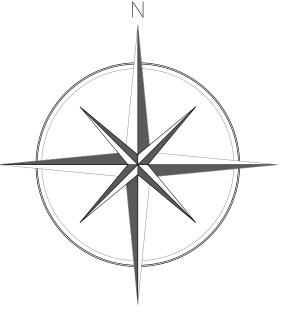

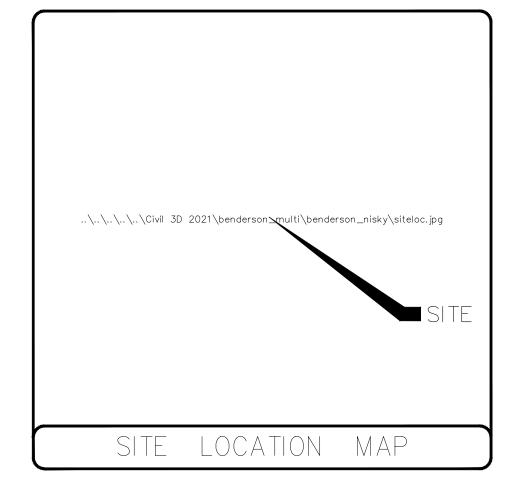

NOTES:

1) SURVEYED PARCEL: TOWN OF AMSTERDAM - TAX MAP 39.00, BLOCK 5, PARCEL 2.

2) SURVEY PREPARED BY GERALD R GRAY, PLS, FROM MAP REFERENCE AND AN APRIL 2021 FIELD SURVEY.

3) NORTH IS REFERENCED TO NAD 83 NEW YORK STATE PLANES EAST ZONE. ELEVATIONS AND TOPOGRAPHY BASED UPON NAVD 88 DATUM.

4) SUBJECT TO ALL RIGHTS, EASEMENTS, COVENANTS OR RESTRICTION; RECORDED OR UNRECORDED.

5) SUBJECT TO ANY STATEMENT OF FACT CONTAINED IN AN UP TO DATE ABSTRACT OF TITLE OR TITLE REPORT.

6) UNDERGROUND UTILITIES IF SHOWN HEREON ARE BASED ON VISIBLE PHYSICAL EVIDENCE. THEY SHOULD BE CONSIDERED SCHEMATIC ONLY AND ARE SHOWN TO DEPICT GENERAL UTILITY CONNECTIONS RATHER THAN EXACT UNDERGROUND LOCATIONS. GERALD R GRAY PLS MAKES NO CERTIFICATION AS TO THE ACCURACY OF THE UNDERGROUND UTILITY LOCATIONS AND OTHER UTILITIES MAY EXIST THAT ARE NOT SHOWN ON THIS MAP. CALL DIGSAFE FOR FURTHER VERIFICATION.

ASSOCIATION OF PROFESSIONAL LAND SURVEYORS CODE OF PRACTICE FOR LAND SURVEYS AS ADOPTED IN OCTOBER OF 1966 AND LAST REVISED ON JULY 18, 1997.

GRAPHIC SCALE

(IN FEET)

1 inch = 20 ft.

O

..\..\12-15 GRG STAMP.jpg

Gerald R Gray NYSPLS 50513

UNAUTHORIZED ALTERATION OR ADDITION
TO THIS SURVEY MAP IS A VIOLATION OF
SECTION 7209 SUBDIVISION 2 OF THE
NEW YORK STATE EDUCATION LAW.
COPIES OF THIS SURVEY MAP NOT
BEARING THE LAND SURVEYOR'S
EMBOSSED SEAL SHALL NOT BE
CONSIDERED TO BE VALID COPIES.
CERTIFICATES INDICATED OR IMPLIED
HEREON SHALL RUN ONLY TO THE PARTY
FOR WHOM THE SURVEY IS PREPARED,
AND ON THEIR BEHALF TO THE
ADDITIONAL PARTIES LISTED HEREON.
CERTIFICATES ARE NOT TRANSFERABLE
TO ADDITIONAL PARTIES, OR SUBSEQUENT
OWNERS, NOT LISTED HEREON.

Drawn: GRG Date: 4/14/21 Designed:_____ Date:_

Checked: GRG Date: 4/14/21

Project Number

Project Title

Niskayuna Square

Property ID 3722J04

3333-3337 Consaul Road

Niskayuna, NY 12304

Prepared For

BENDERSON DEVELOPMENT

570 DELAWARE AVE., BUFFALO, NY 14202 (716) 886-0211

Drawing Title

Limited Topographic Survey

Drawing Scale: 1" = 20'

> Date: April 14, 2021

Drawing Number

1 of 1


GENERAL NOTES:


1. INSTALL ALL MATERIALS TO MANUFACTURER'S RECOMMENDATIONS AND BEST STANDARDS OF TRADE


- 2. SUBSTITUTIONS SHALL BE MADE ONLY WITH OWNER'S APPROVAL AND BE OF EQUIVALENT QUALITY TO WHAT IS SPECIFIED.
- 3. WORK SHALL BE COMPLETED IN STRICT ACCORDANCE WITH ALL LOCAL CODES AND OSHA SAFETY RULES AND REGULATIONS.
- 4. CONTRACTOR SHALL VERIFY ALL EXISTING CONDITIONS AND DIMENSIONS AT THE SITE. NOTIFY OWNER & ENGINEER OF DISCREPANCIES IN CONDITIONS SHOWN ON DRAWINGS PRIOR TO PROCEEDING WITH THE
- 5. CONTRACTOR SHALL BE RESPONSIBLE FOR PROTECTION OF ANY EXISTING STRUCTURES TO REMAIN AND ANY FINISH MATERIAL INSTALLED WHILE WORKING ON OTHER COMPONENTS. 6. CONTRACTOR SHALL KEEP JOB FREE OF DEBRIS AND MAKE FINAL CLEANUP TO THE SATISFACTION OF
- 7. CONTRACTOR SHALL ASCERTAIN THE LOCATION OF ALL UTILITIES PRIOR TO CONSTRUCTION SO THAT THIS
- WORK WILL NOT DISTURB EXISTING LINES AND/OR INSTALLATIONS EXCEPT AS DETAILED ON THE PLANS. COORDINATE ALL WORK WITH THE APPLICABLE UTILITY COMPANIES. 8. CONTRACTOR SHALL OBTAIN AND PAY FOR ALL REQUIRED PERMITS NECESSARY TO PERFORM THE WORK. 9. BUILDING DIMENSIONS ARE APPROXIMATE. REFER TO ARCHITECTURAL DRAWINGS FOR LAYOUT
- 10. SIDEWALK DIMENSIONS ARE APPROXIMATE. REFER TO ARCHITECTURAL DRAWINGS FOR THE SIDEWALK
- PLAN. 11. CONCRETE SIDEWALK SEALERS: (REFER TO ARCHITECTURAL PLANS FOR LOCATION OF CONCRETE TYPES.)
- 11.1. GREY CONCRETE SIDEWALKS SHALL HAVE CHEMMASTERS SILENCURE WITHIN 2HRS AFTER FINAL FINISHING OF CONCRETE AND ALL BLEED WATER HAS DISSIPATED.
- 11.2. EXPOSED AGGREGATE/STAMPED CONCRETE SIDEWALKS SHALL HAVE ONE (x1) COAT CHEMMASTERS - SILENCURE AS SOON AS CONCRETE HAS DRIED AFTER PRESSURE-WASHING THE RELEASE AGENT OFF. APRX 30 DAYS AFTER THIS (IF WEATHER PERMITS) APPLY ONE (x1) COAT OF CHEMMASTERS - POLYSEAL EZ.
- 12. LIGHTING FIXTURE ARROW SYMBOLS REFER TO THE DIRECTION THAT THE FIXTURES ARE REQUIRED TO FACE. SPECIFIC MOUNT BRACKETS WILL BE REQUIRED DEPENDING ON ORIENTATION AND FIXTURE
- 13. CURB ISLAND DIMENSIONS ARE FROM INSIDE OF CURB TO INSIDE OF CURB.

DEMOLITION NOTES: (#) 1. Existing Curb to Remain.

- 2. Existing Curb to be Removed.
- 3. Limit of Curb Removal.
- 4. Limit of Sidewalk Removal.
- Existing Concrete Sidewalk to be Removed.
- Existing Striping to be Removed.
- Existing Ramp to be Removed.

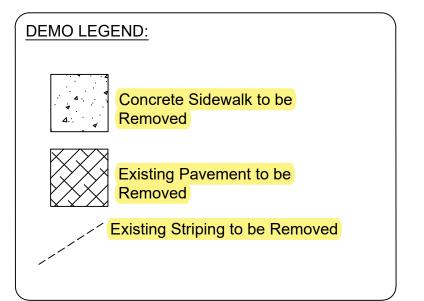

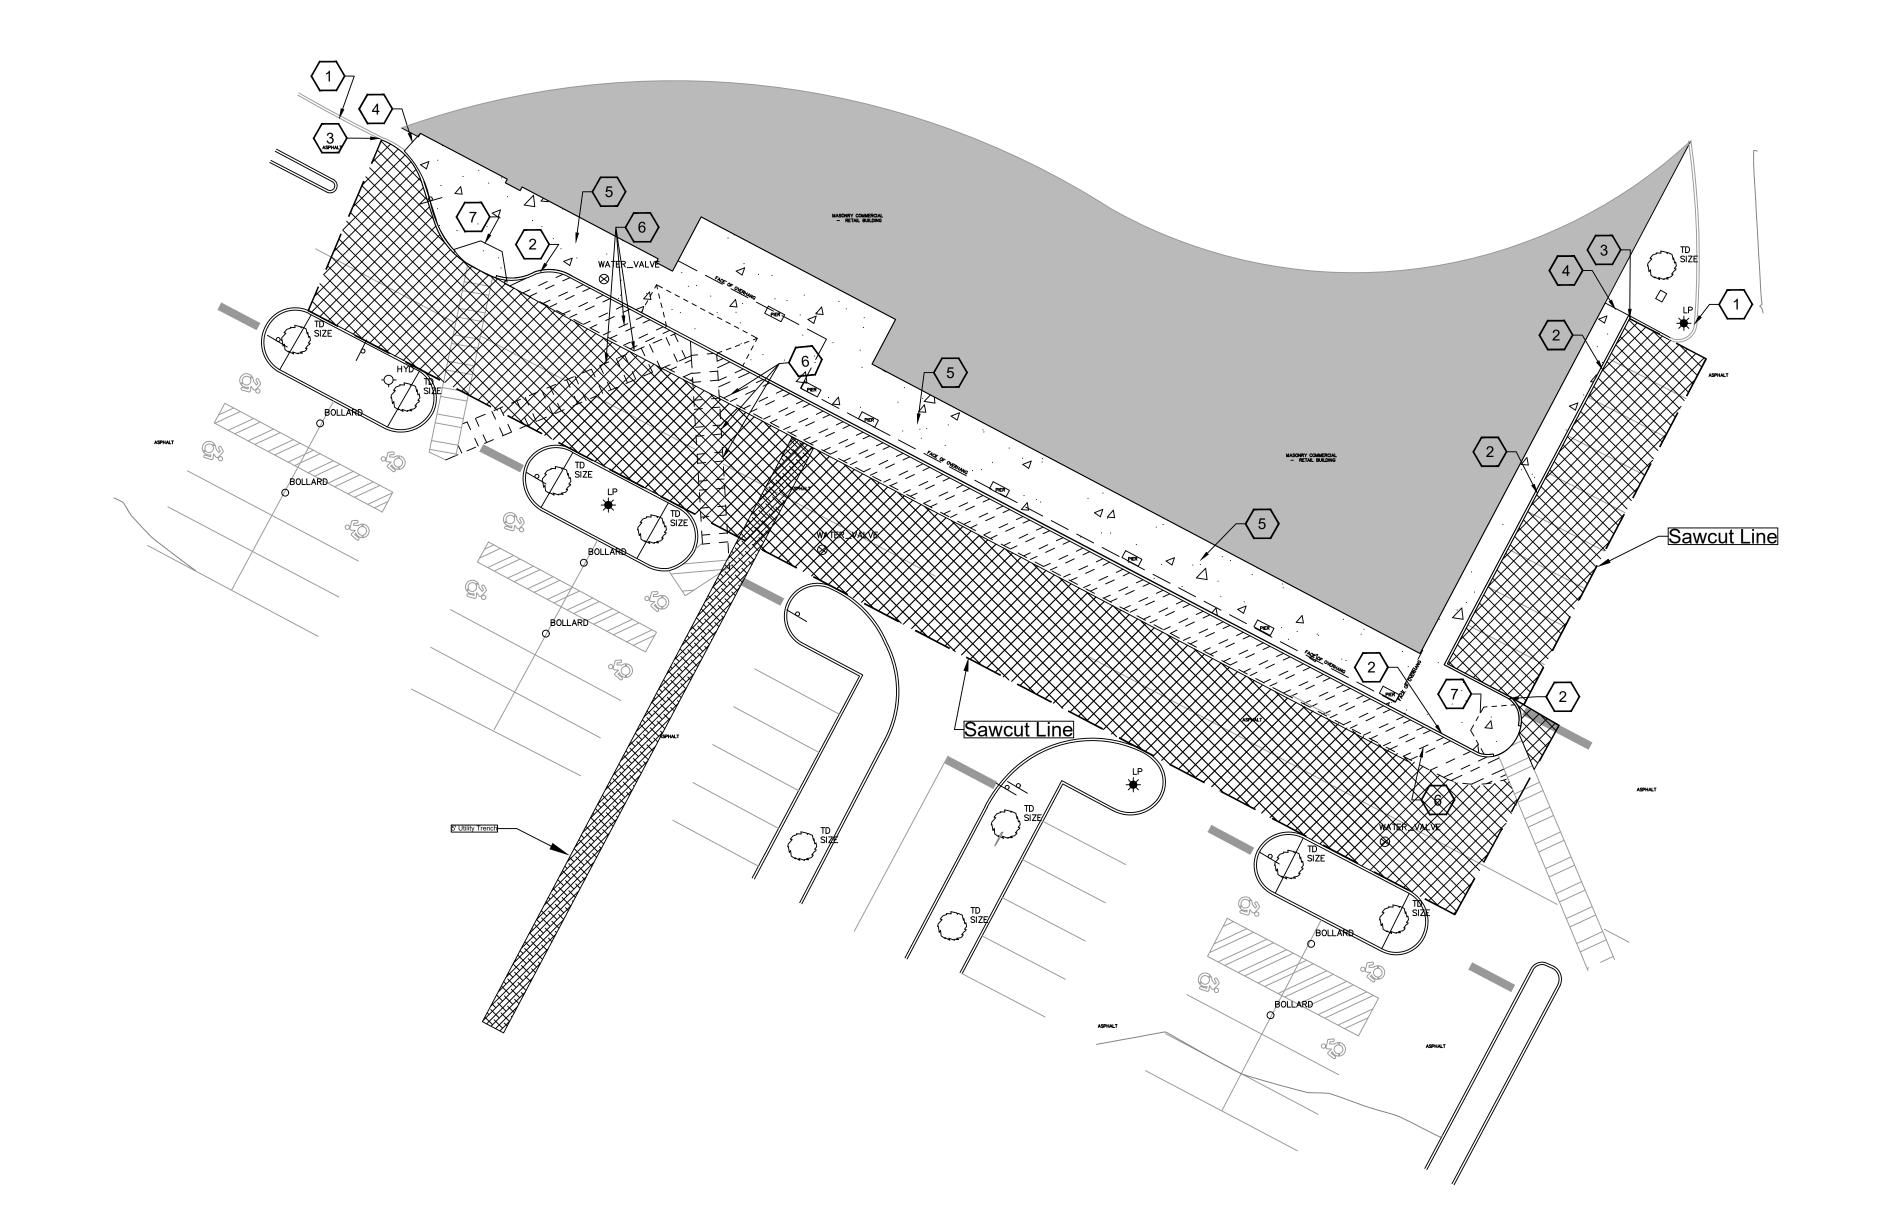

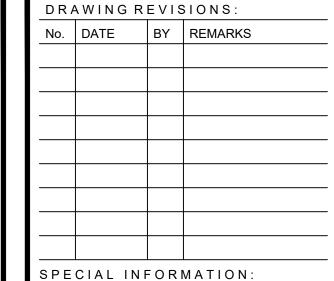

ALL CONTRACTORS SHALL GUARANTEE THEIR WORK FOR A PERIOD OF ONE YEAR FROM THE DATE OF OWNERS ACCEPTANCE.

SHOP DRAWING SUBMITTALS ARE REQUIRED FOR ANY AND ALL STRUCTURES.

NOTICE

UNAUTHORIZED ALTERATIONS OF THIS DOCUMENT ARE IN VIOLATION OF SECTION #7209 OF THE STATE





PROPERTY NUMBER: # 3722

AREA:

CE

SIDEW.

-333 **KAY**I

3333 NISI

CONSULTANT

JAMES ALLEN RUMSEY
ARCHITECT
PREPARED FOR

(716) 886-0211

SEAL




Demolition Plan

DATE: 07.28.21


SITE NOTES: 1. Proposed 6" concrete Curb. 2. Proposed Flush Concrete Curb.

- 3. Match into Existing Curb. 4. Proposed Concrete Sidewalk.
- 5. Proposed ADA Curb Ramp
- 6. Proposed Crosswalk Striping
- 7. Match into Existing Striping. 8. Limit of Sidewalk Removal

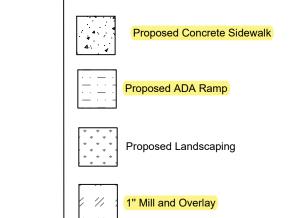


Match into Existing Pavement


SITE LEGEND:

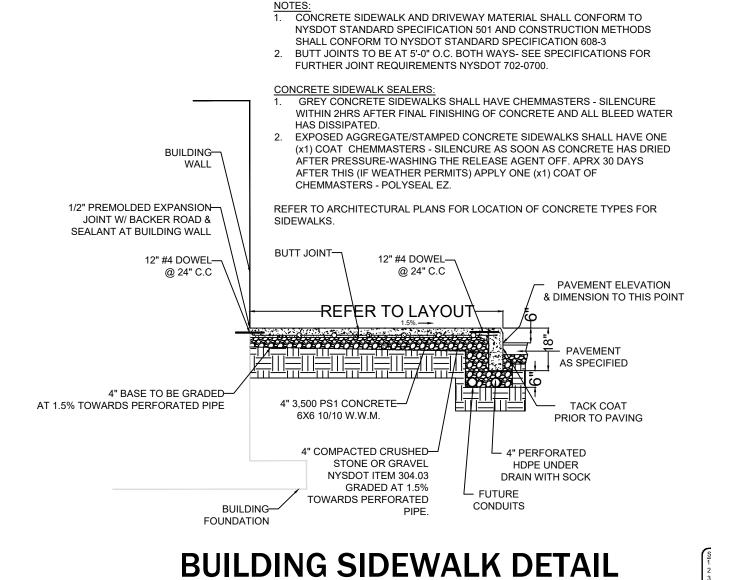


CONTRACTOR TO VERIFY WITH OWNER ON CURB DETAIL

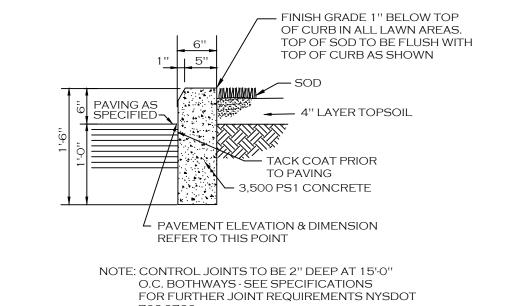


TYPE "A" CONCRETE CURB

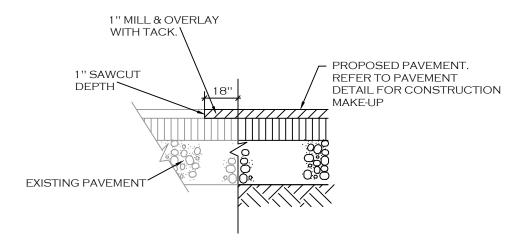

PAVEMENT TRANSITION DETAIL (ASPHALT PAVEMENT)

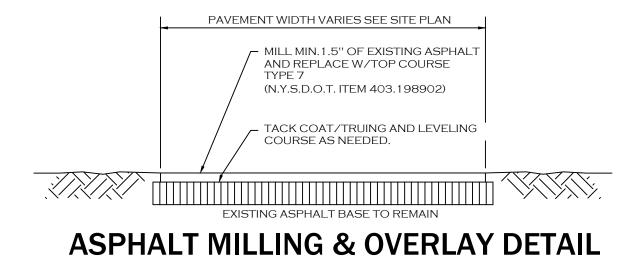

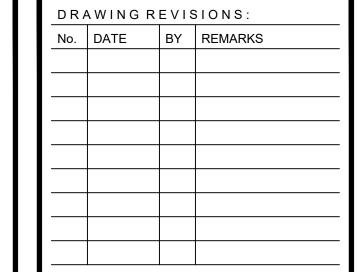

SPECIAL INFORMATION: ALL CONTRACTORS SHALL GUARANTEE THEIR WORK FOR A PERIOD OF ONE YEAR FROM THE DATE OF OWNERS ACCEPTANCE.

SHOP DRAWING SUBMITTALS ARE REQUIRED FOR ANY AND ALL STRUCTURES.

NOTICE

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PROPERTY NUMBER: # 3722

AREA:

ACEMENT

REPL/

SIDEM


AUL RD 7 12304 3333-3337 CONS/ NISKAYUNA, NY

CONSULTANT

JAMES ALLEN RUMSEY
ARCHITECT
PREPARED FOR


570 DELAWARE AVE., BUFFALO, NY 14202 (716) 886-0211


SEAL

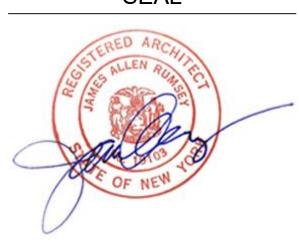

Overall Site Plan

DATE: 07.28.21

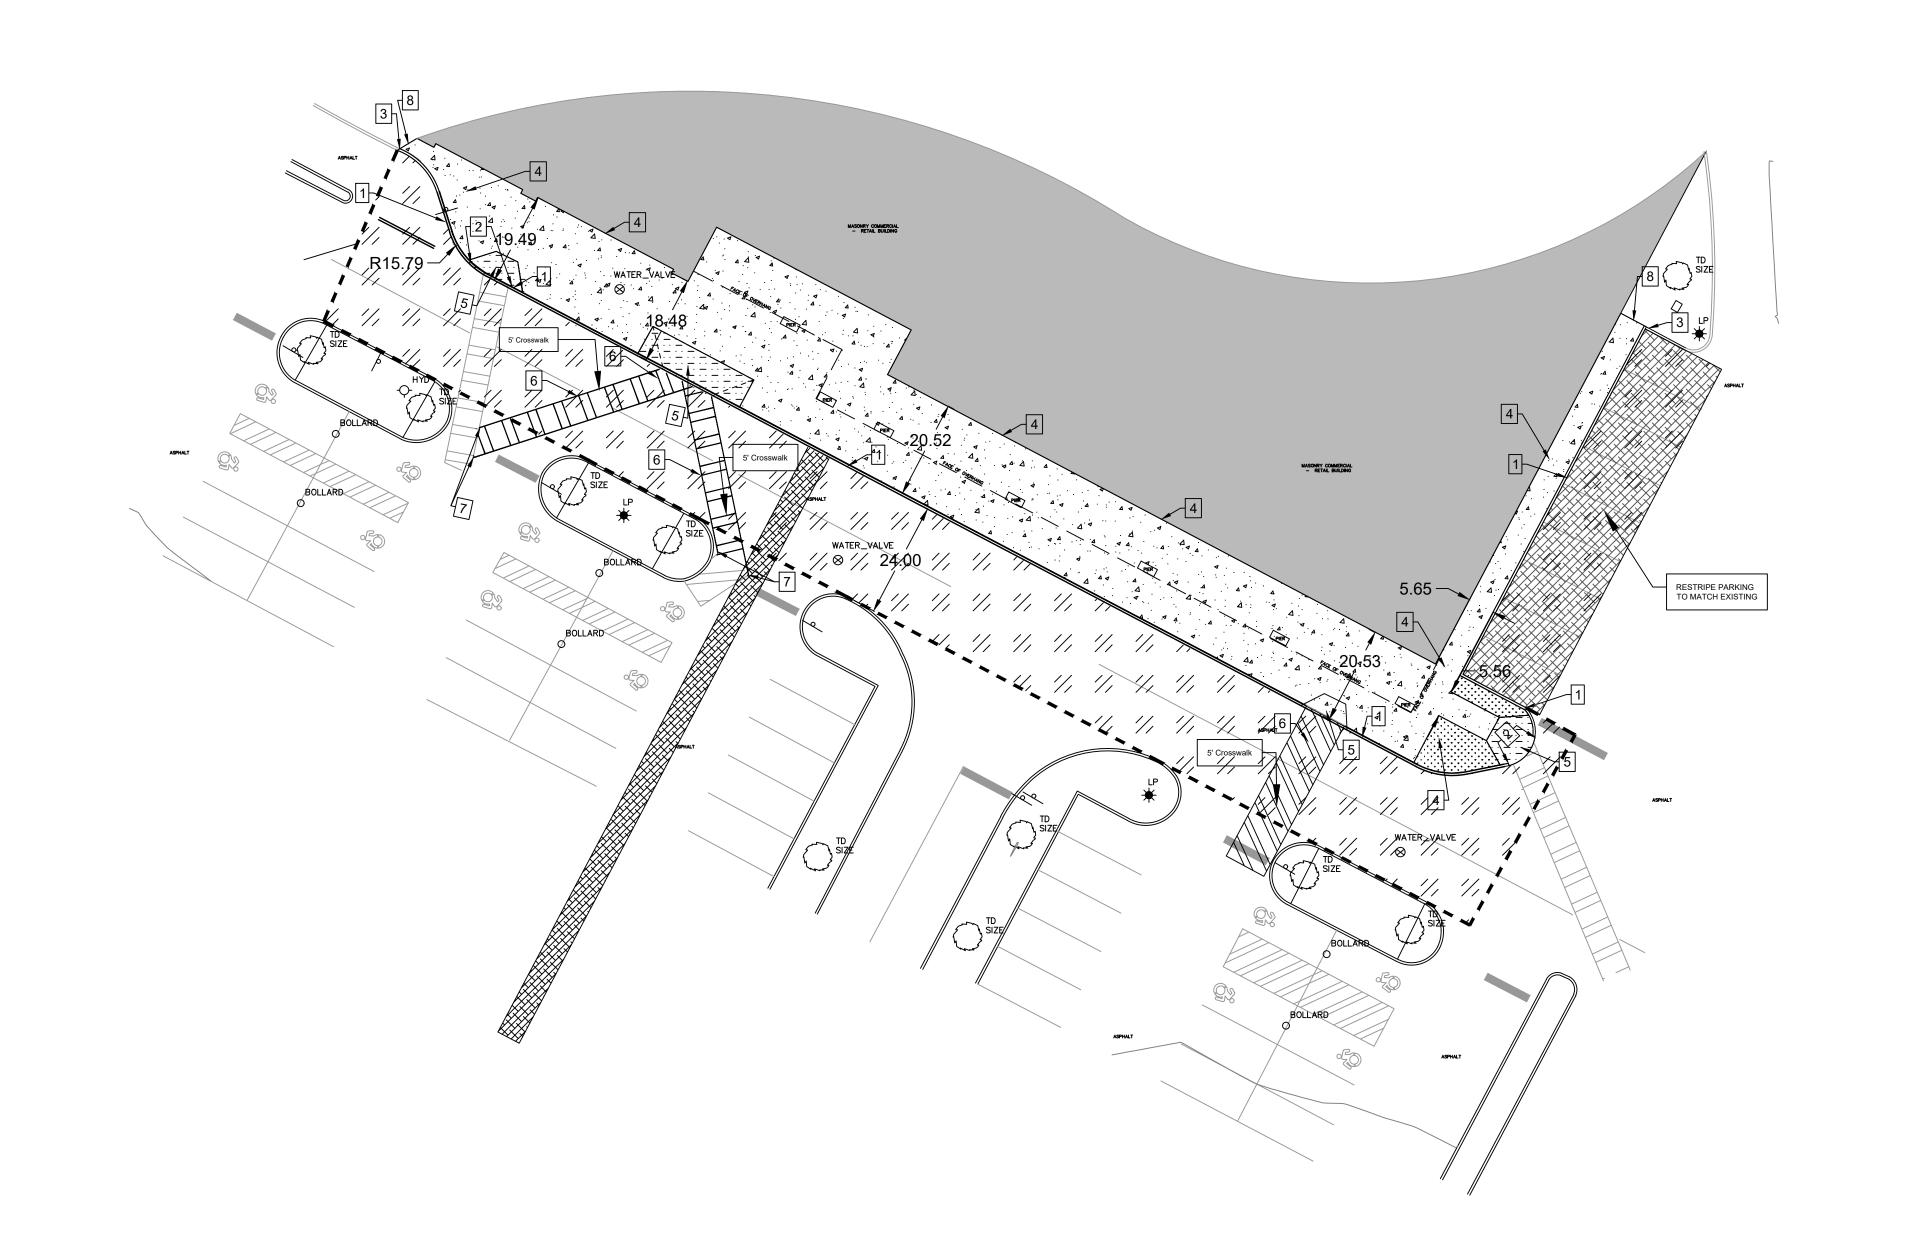

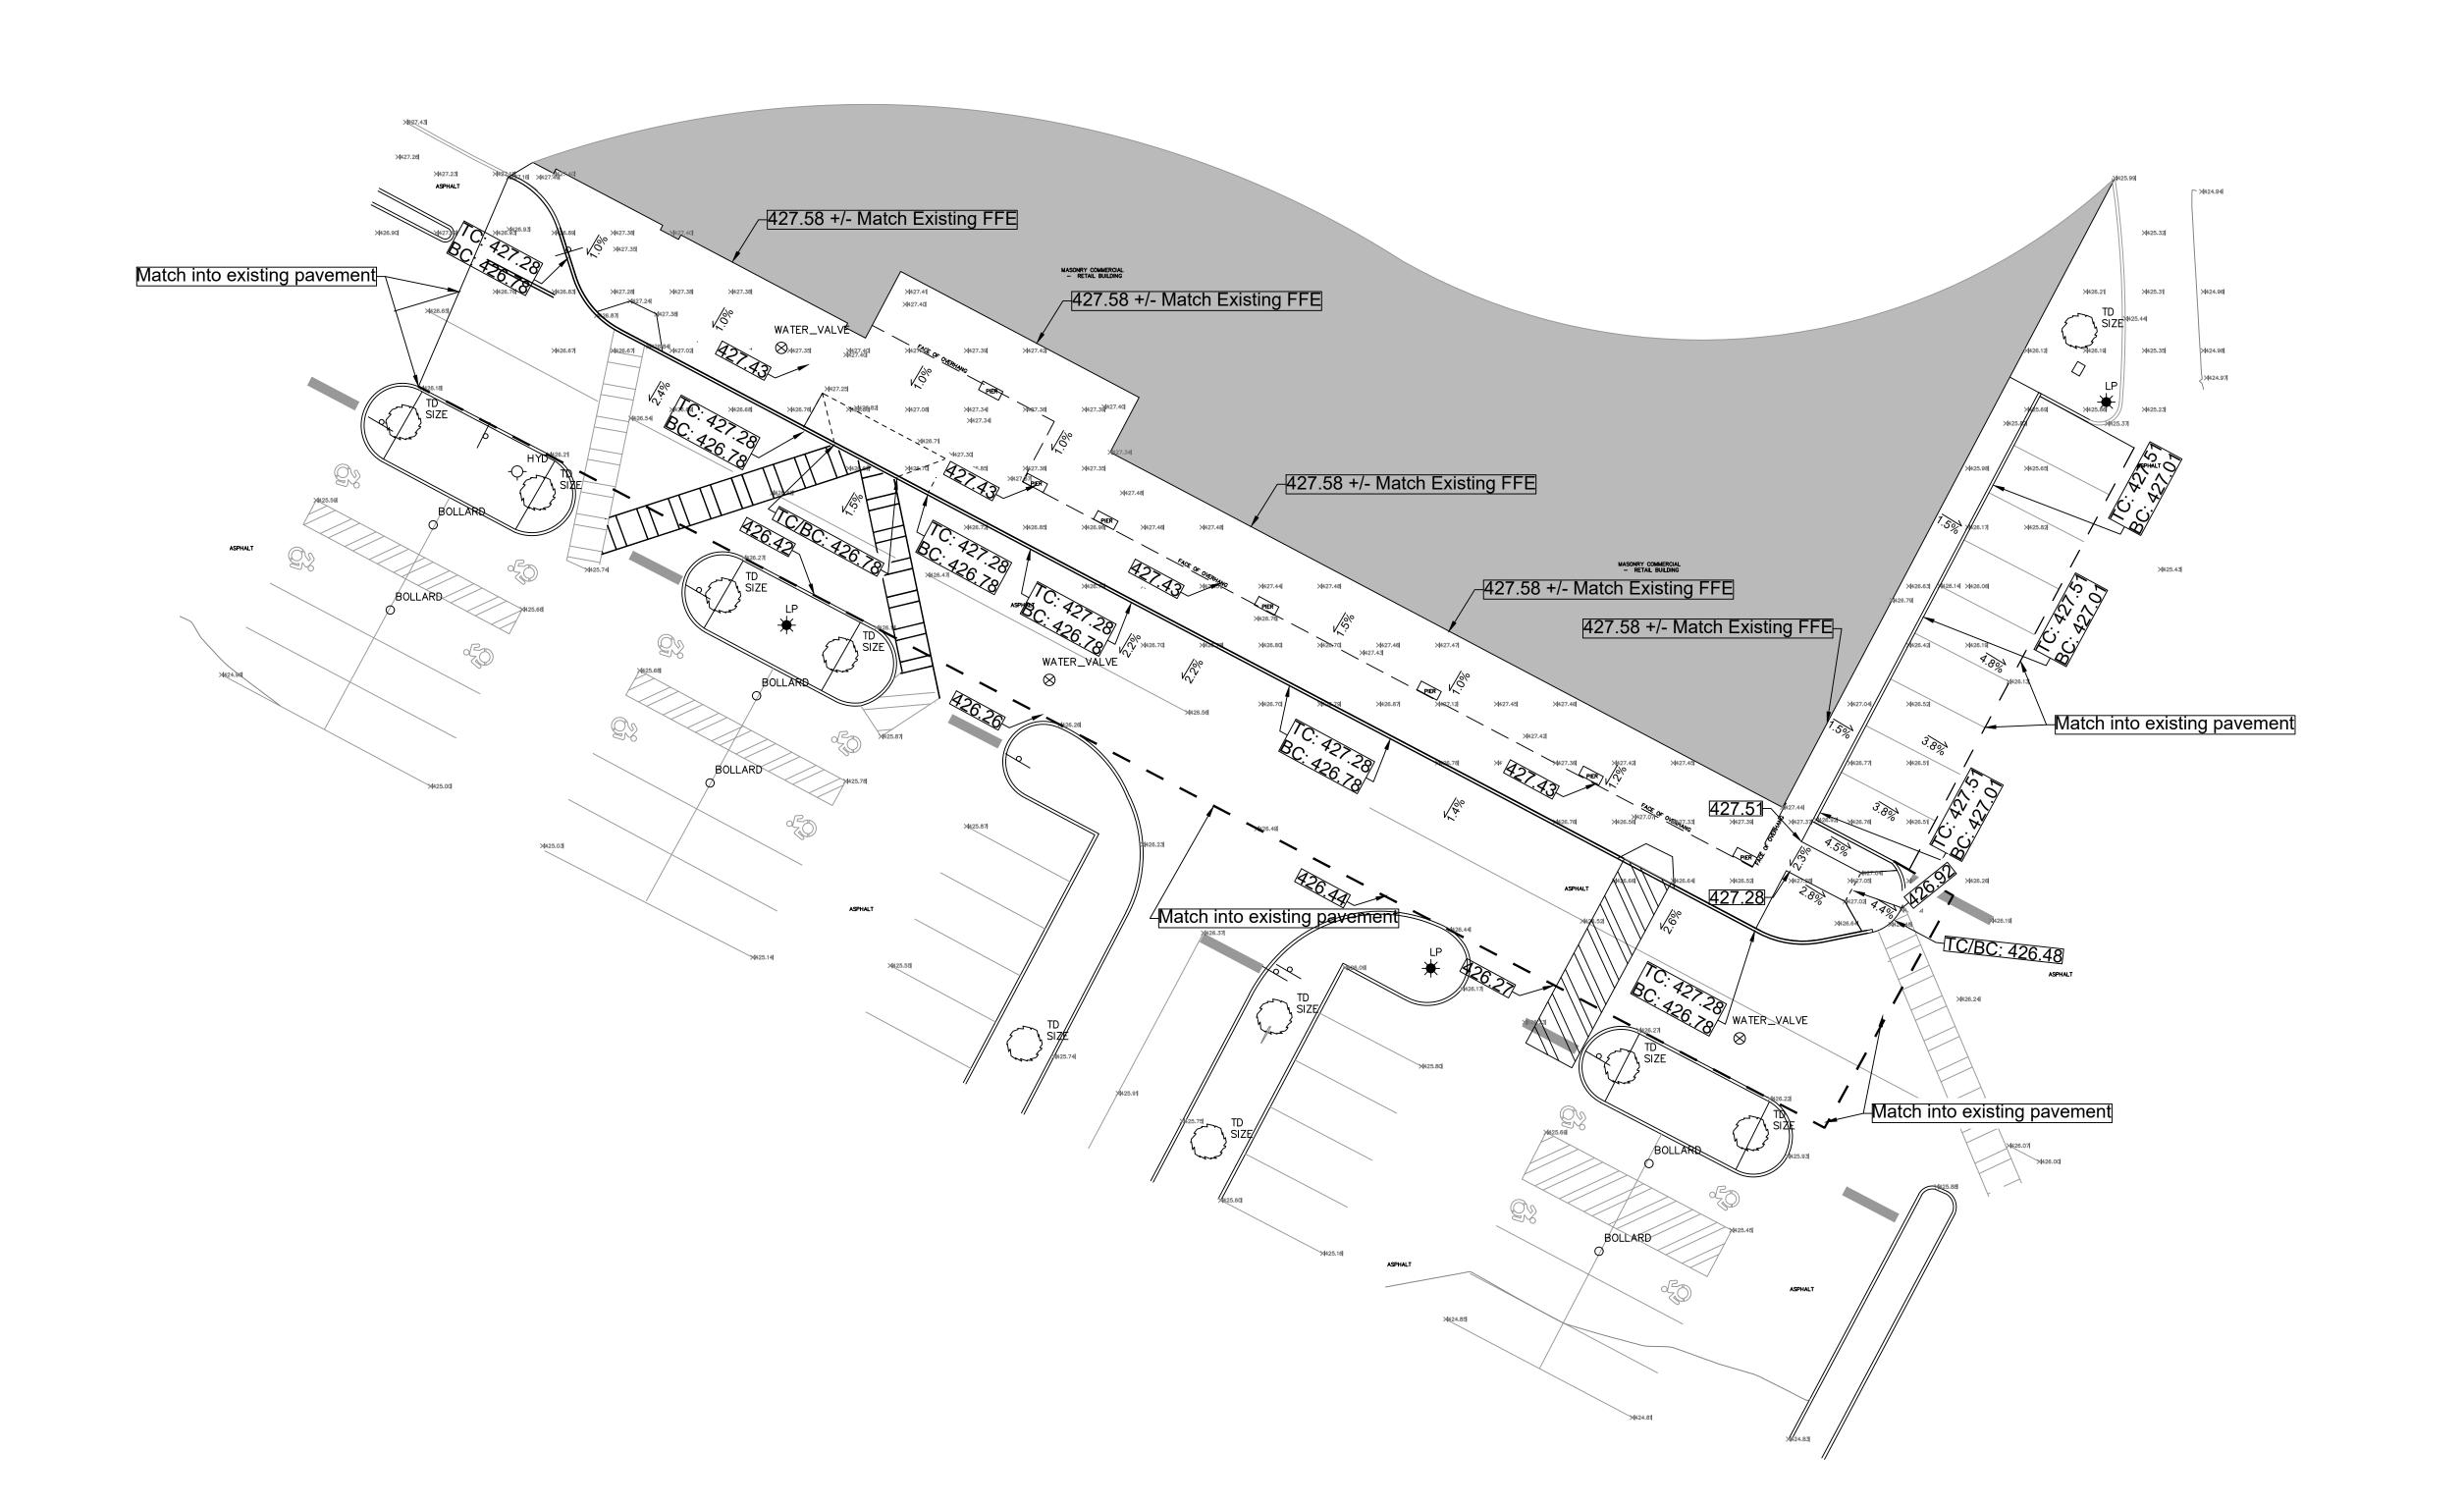

	DRAWING REVISIONS:				
	No.	DATE	BY	REMARKS	
- 1					

S P E C I A L I N F O R M A T I O N :

ALL CONTRACTORS SHALL GUARANTEE THEIR WORK
FOR A PERIOD OF ONE YEAR FROM THE DATE OF
OWNERS ACCEPTANCE.

OWNERS ACCEPTANCE.

SHOP DRAWING SUBMITTALS ARE REQUIRED FOR ANY AND ALL STRUCTURES.

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PROPERTY NUMBER: # 3722

37 CONSAUL RD 7UNA, NY 12304

333 E

CONSULTANT

SIDE

JAMES ALLEN RUMSEY

ARCHITECT
PREPARED FOR

DEVELOPMENT
570 DELAWARE AVE., BUFFALO, NY 14202
(716) 886-0211


SEAL




Grading Plan


SCALE:
1:16
DRAWN BY:
KER


KER
CHECKED BY:
MAO
DATE:
07.28.21

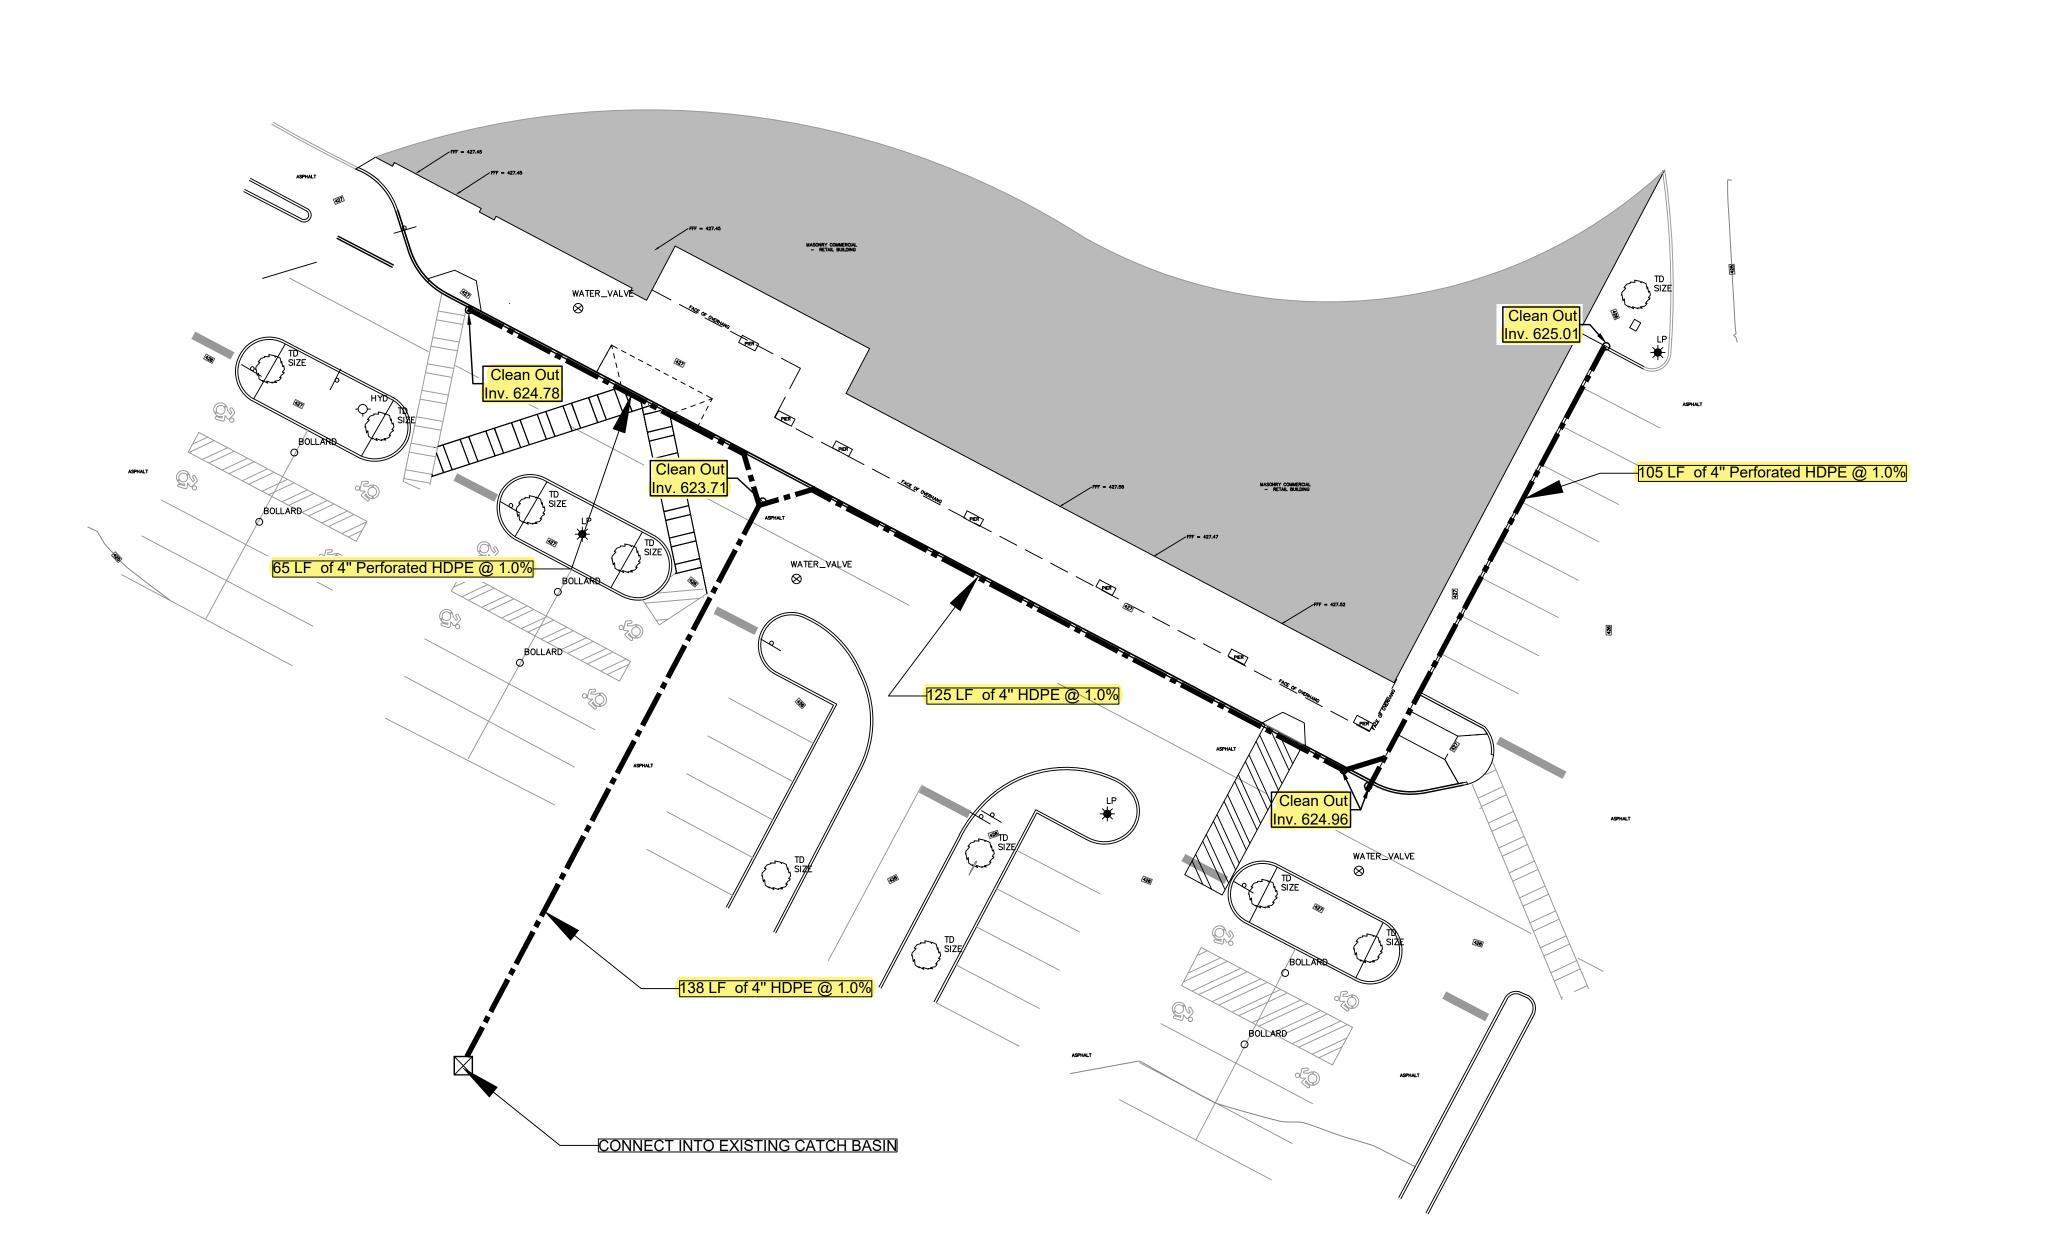

DRAINAGE LEGEND: PROPOSED UNDERDRAIN PROPOSED STORM CLEAN OUT / WYE CONNECTION CB -# EXISTING CATCH BASIN

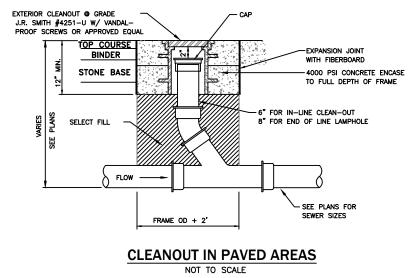

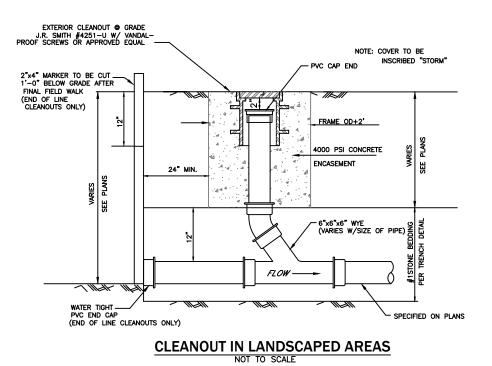

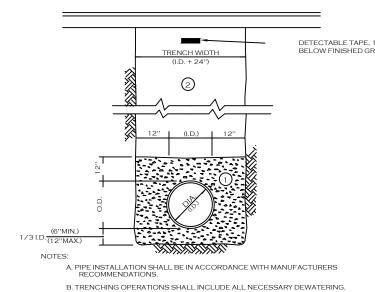

C. TRENCH DETAILS ARE ONLY SHOWN FOR PURPOSES OF MATERIAL PLACEMENT AND MAXIMUM PAY LIMITS. D. AN OSHA APPROVED MOVABLE PROTECTIVE TRENCH SHIELD SHALL BE USED IN ALL UNSHEETED TRENCH AREAS.

<u>MATERIALS</u>

PIPE BEDDING MATERIAL (NYSDOT 1985 EDITION) NO. 1 CRUSHED STONE OR CRUSHED GRAVEL WITH A GRADATION CONFORMING WITH NYSDOT SECTION 703-02. THE MATERIAL SHALL BE WELL GRADED WITH NO PARTICLES LARGER THAN ONE INCH AND HAVING A MAXIMUM GRADATION MEETING THE LIMITS DESCRIBED IN THE SPECIFICATIONS. THE BEDDING SHALL BE COMPACTED IN 6" LIFTS WITH EQUIPMENT ACCEPTABLE TO THE PIPE MANUFACTURER.

NO SLAG SHALL BE ALLOWED FOR MATERIAL 1 2) TYPE 2 CRUSHED STONE OR CRUSHED GRAVEL WITH A GRADATION CONFORMING WITH NYSDOT SECTION 304-2.02 TYPE 2. THE MATERAIL SHALL BE WELL GRADED WITH NO PARTICLES LARGER THAN TWO INCHES AND HAVING A MAXIMUM GRADATION MEETING THE LIMITS DESCRIBED IN THE SPECIFICATIONS. THE BEDDING SHALL BE COMPACTED IN 6" LIFTS WITH EQUIPMENT ACCEPTABLE TO THE PIPE MANUFACTURER.

NO SLAG SHALL BE ALLOWED FOR MATERIAL 2

UTILITY TRENCH SECTION IN PAVED AREAS

No. DATE BY REMARKS SPECIAL INFORMATION:

DRAWING REVISIONS:

ALL CONTRACTORS SHALL GUARANTEE THEIR WORK FOR A PERIOD OF ONE YEAR FROM THE DATE OF OWNERS ACCEPTANCE.

SHOP DRAWING SUBMITTALS ARE REQUIRED FOR ANY AND ALL STRUCTURES.

NOTICE

UNAUTHORIZED ALTERATIONS OF THIS DOCUMENT ARE IN VIOLATION OF SECTION #7209 OF THE STATE EDUCATION LAW.





PROPERTY NUMBER: # 3722

AREA:

333

SIDE

CONSULTANT

JAMES ALLEN RUMSEY
ARCHITECT
PREPARED FOR

570 DELAWARE AVE., BUFFALO, NY 14202

SEAL

(716) 886-0211



Storm Drainage Plan

SCALE: 1:20 DRAWN BY: DRAWING NO. KER CHECKED BY:

DATE: 07.28.21

3333/3337 Consaul Road

